



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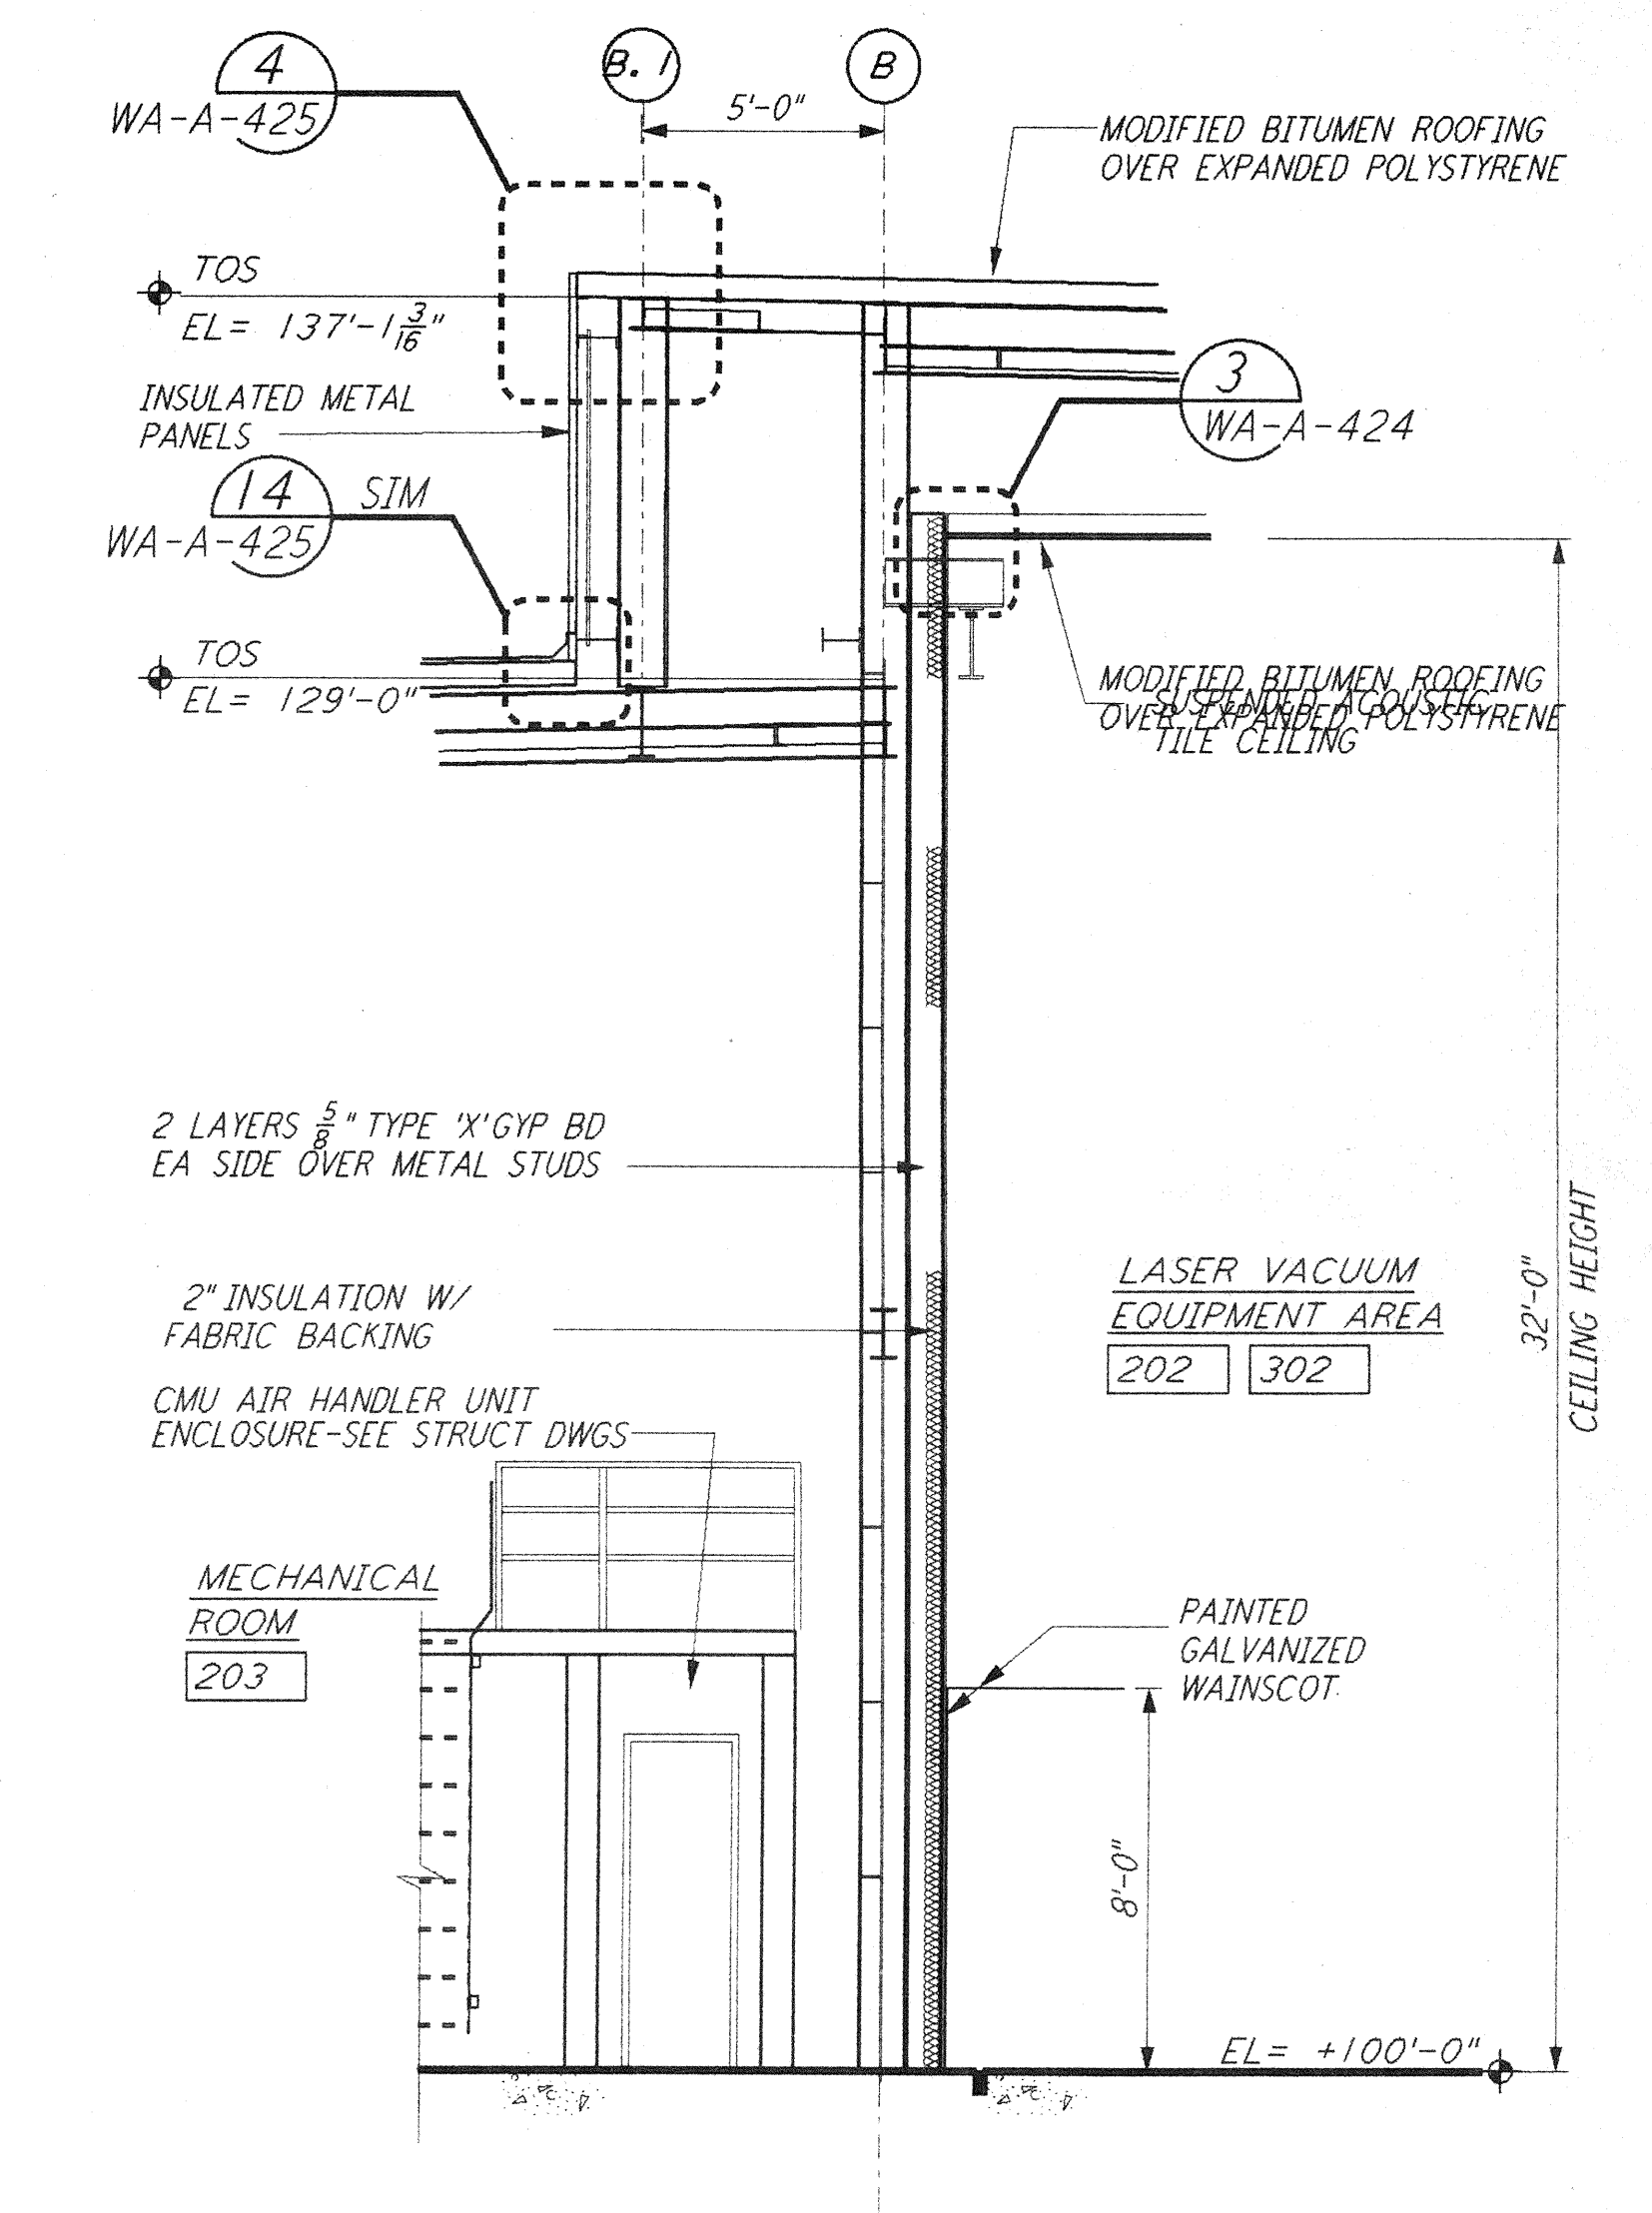
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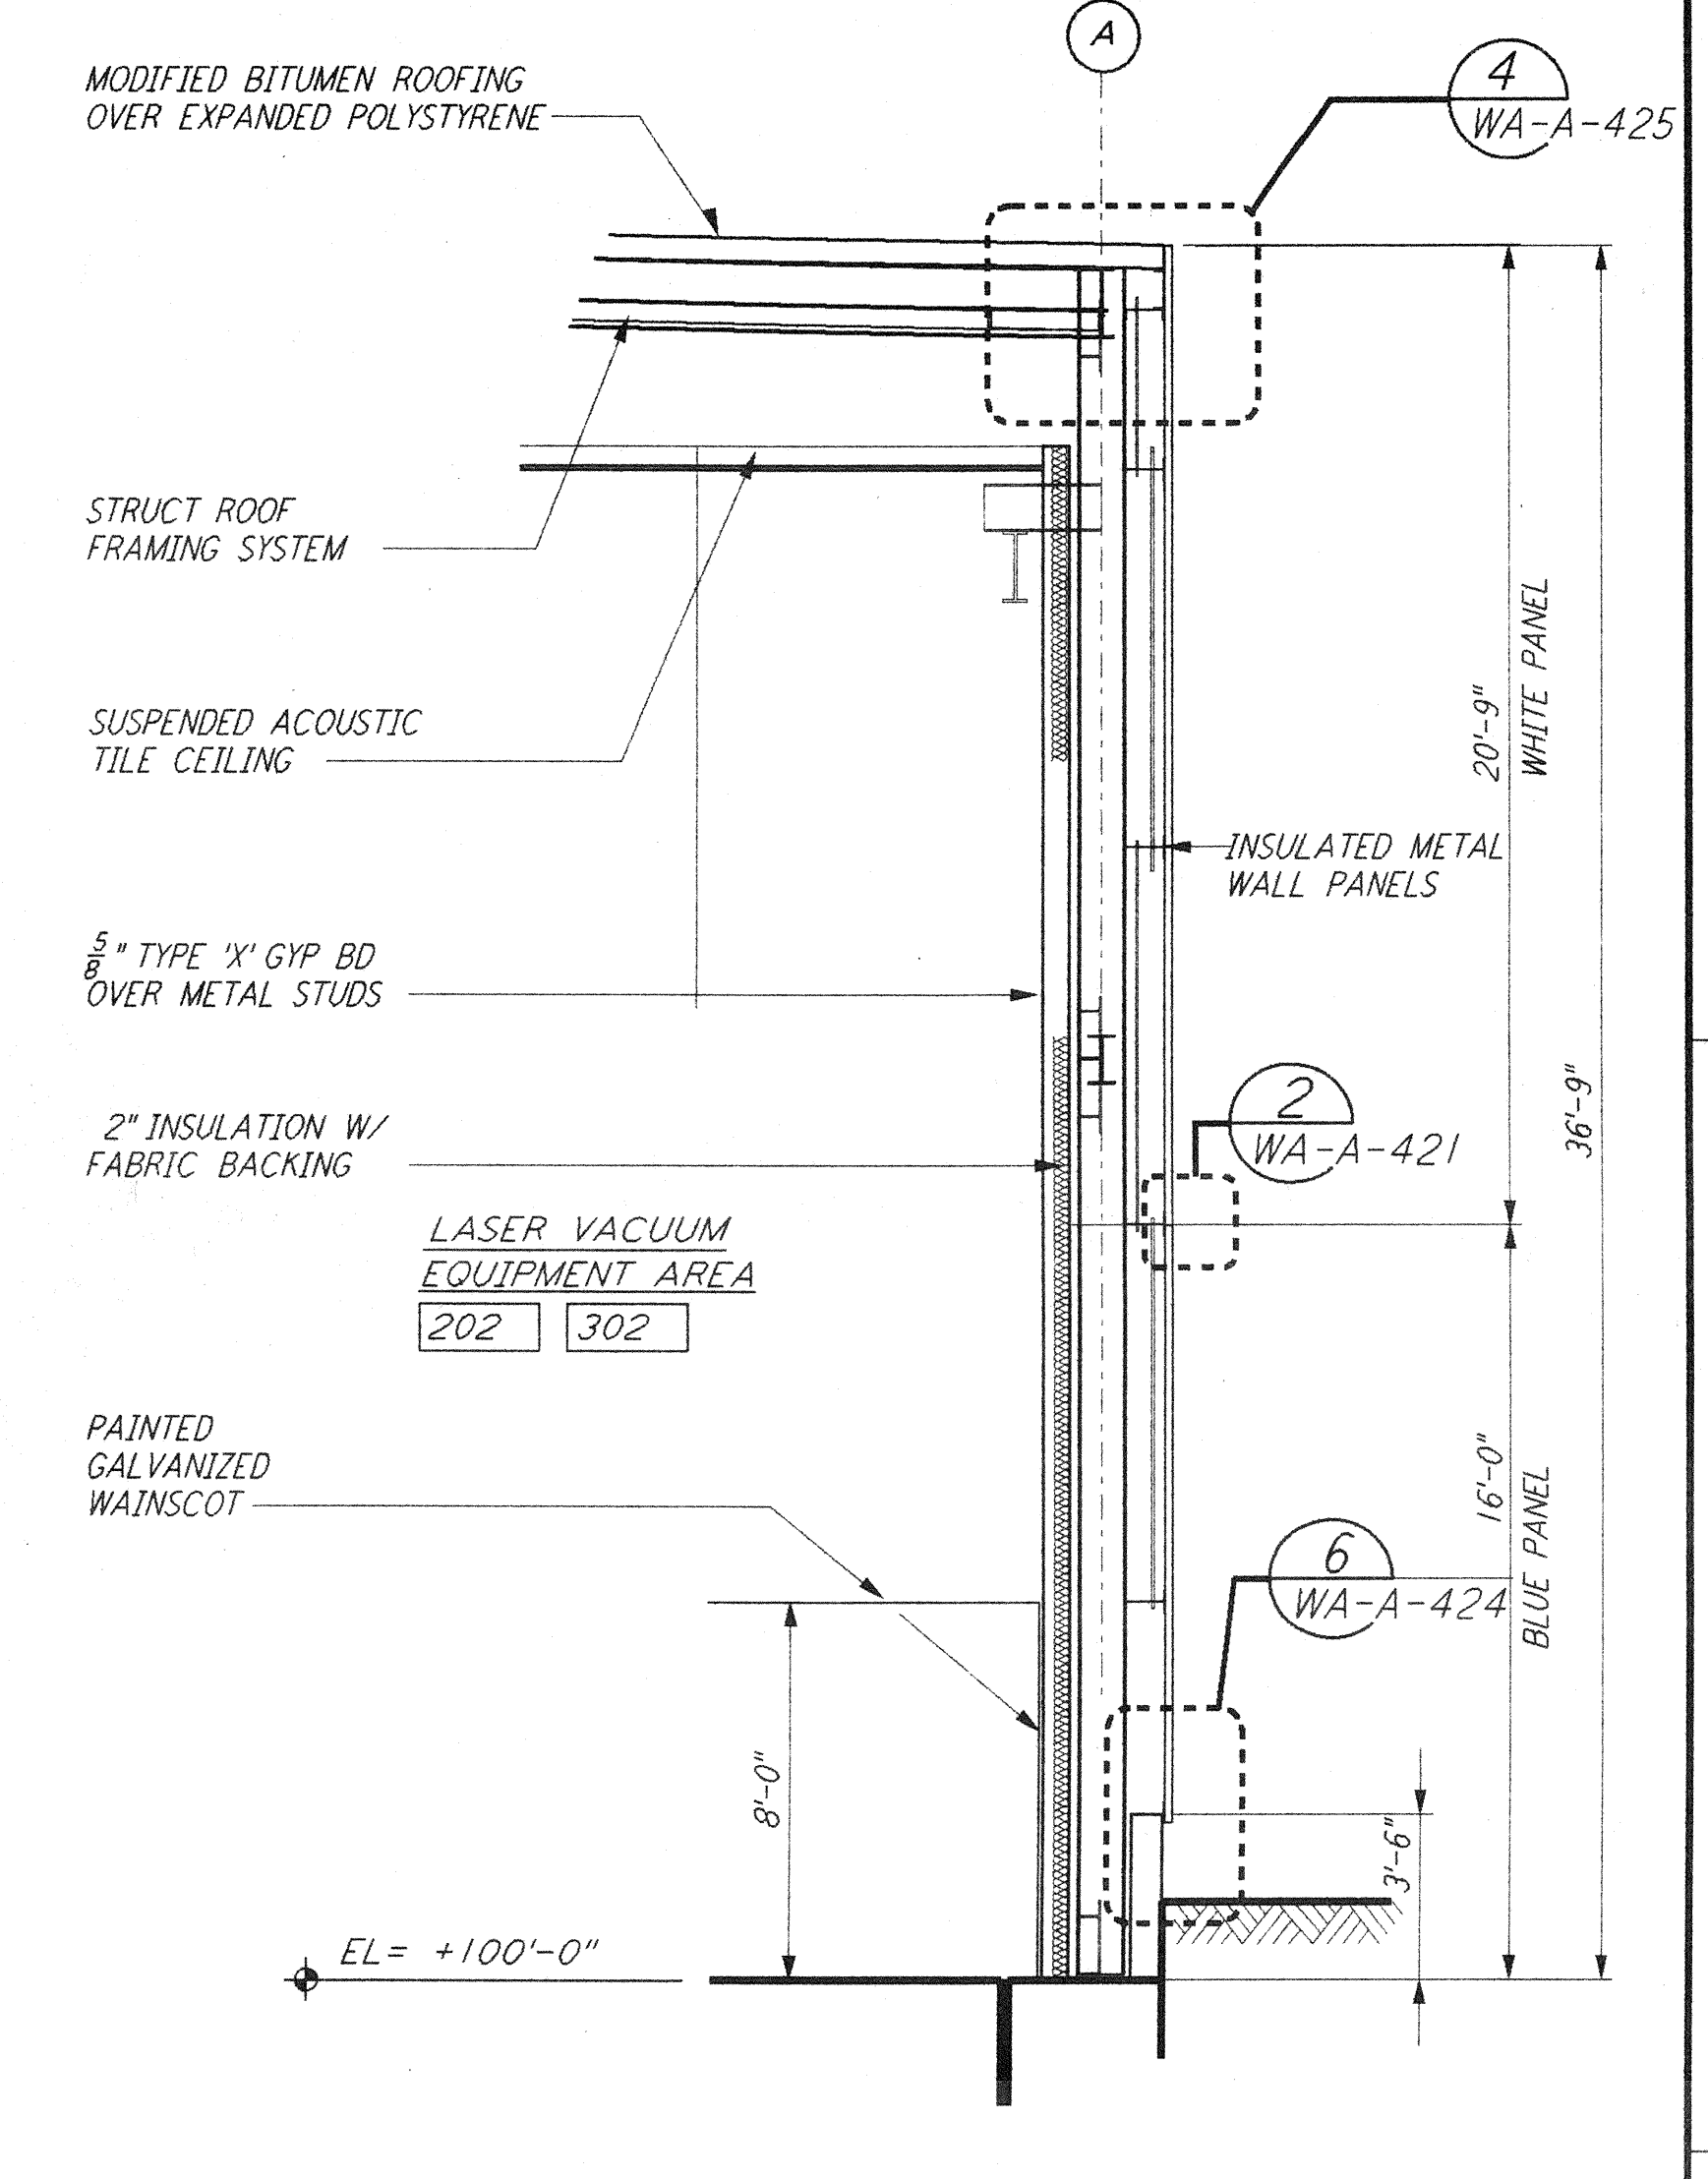
WALL SECTION
 1/4" = 1'-0"
 G REF
 WA-A-261 WA-A-251

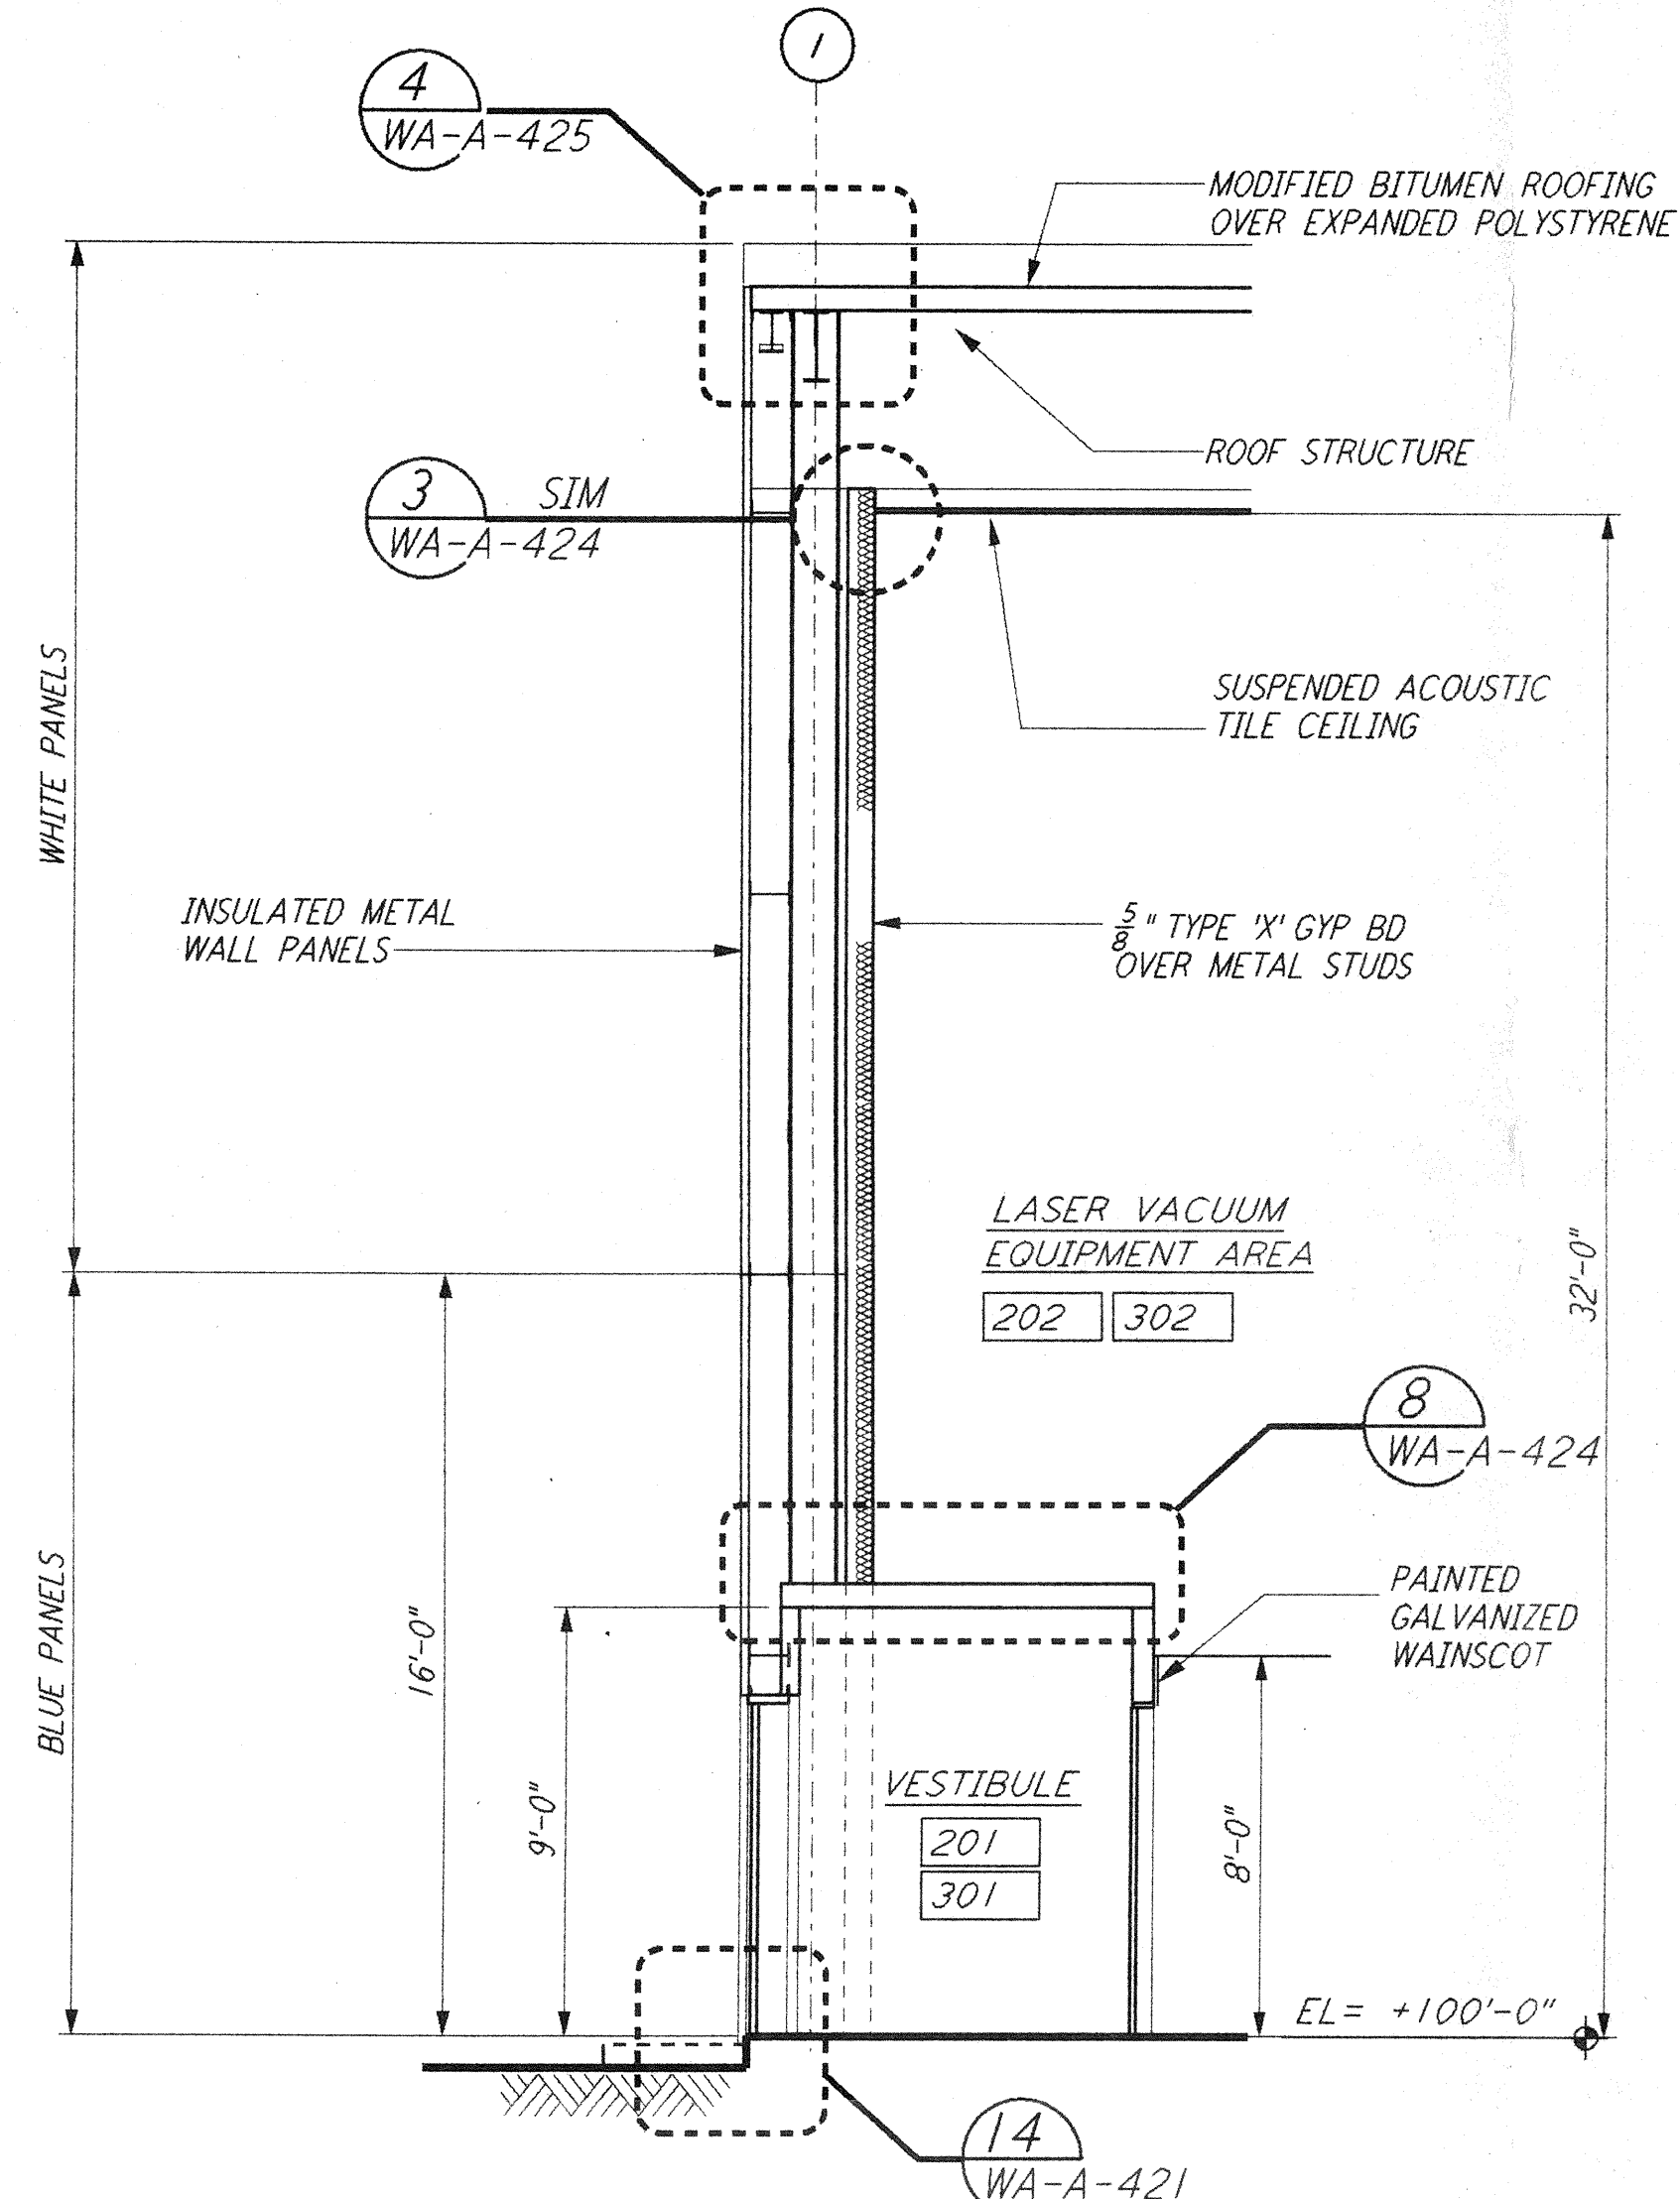


WALL SECTION
 1/4" = 1'-0"
 E REF
 WA-A-261 WA-A-251

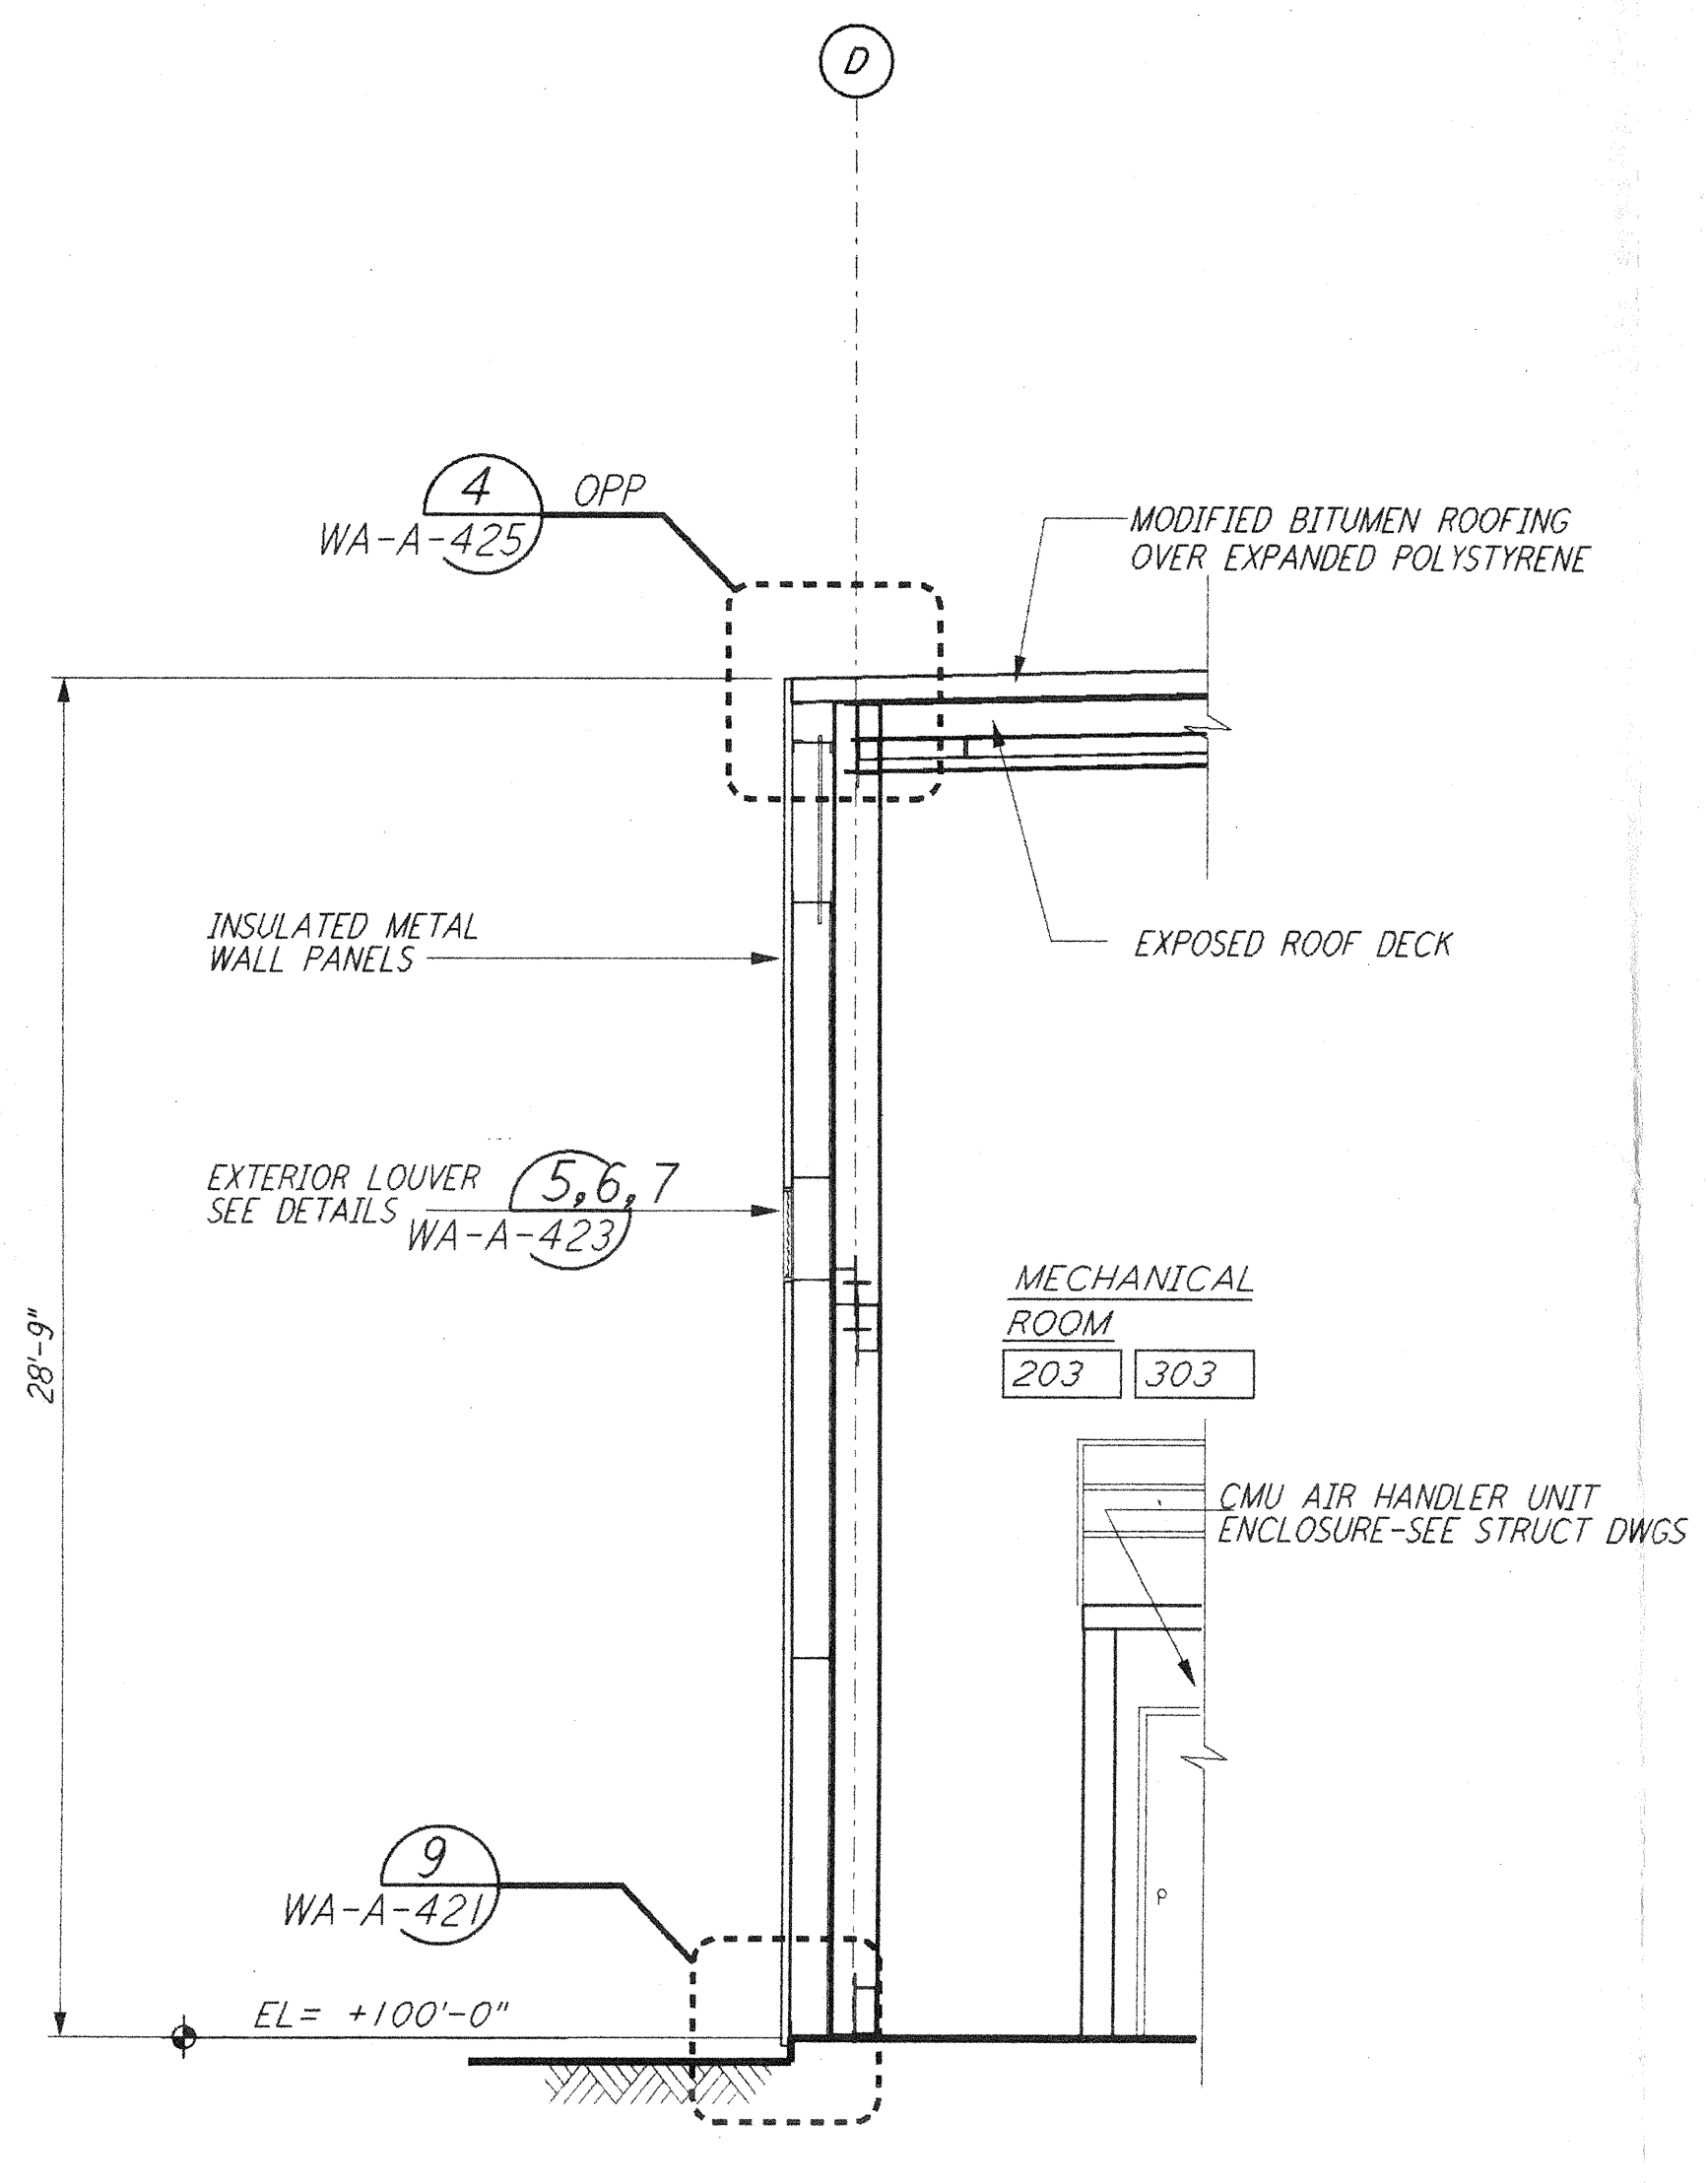


WALL SECTION
 1/4" = 1'-0"
 C REF
 WA-A-261 WA-A-251




WALL SECTION
 1/4" = 1'-0"
 A REF
 WA-A-261 WA-A-251

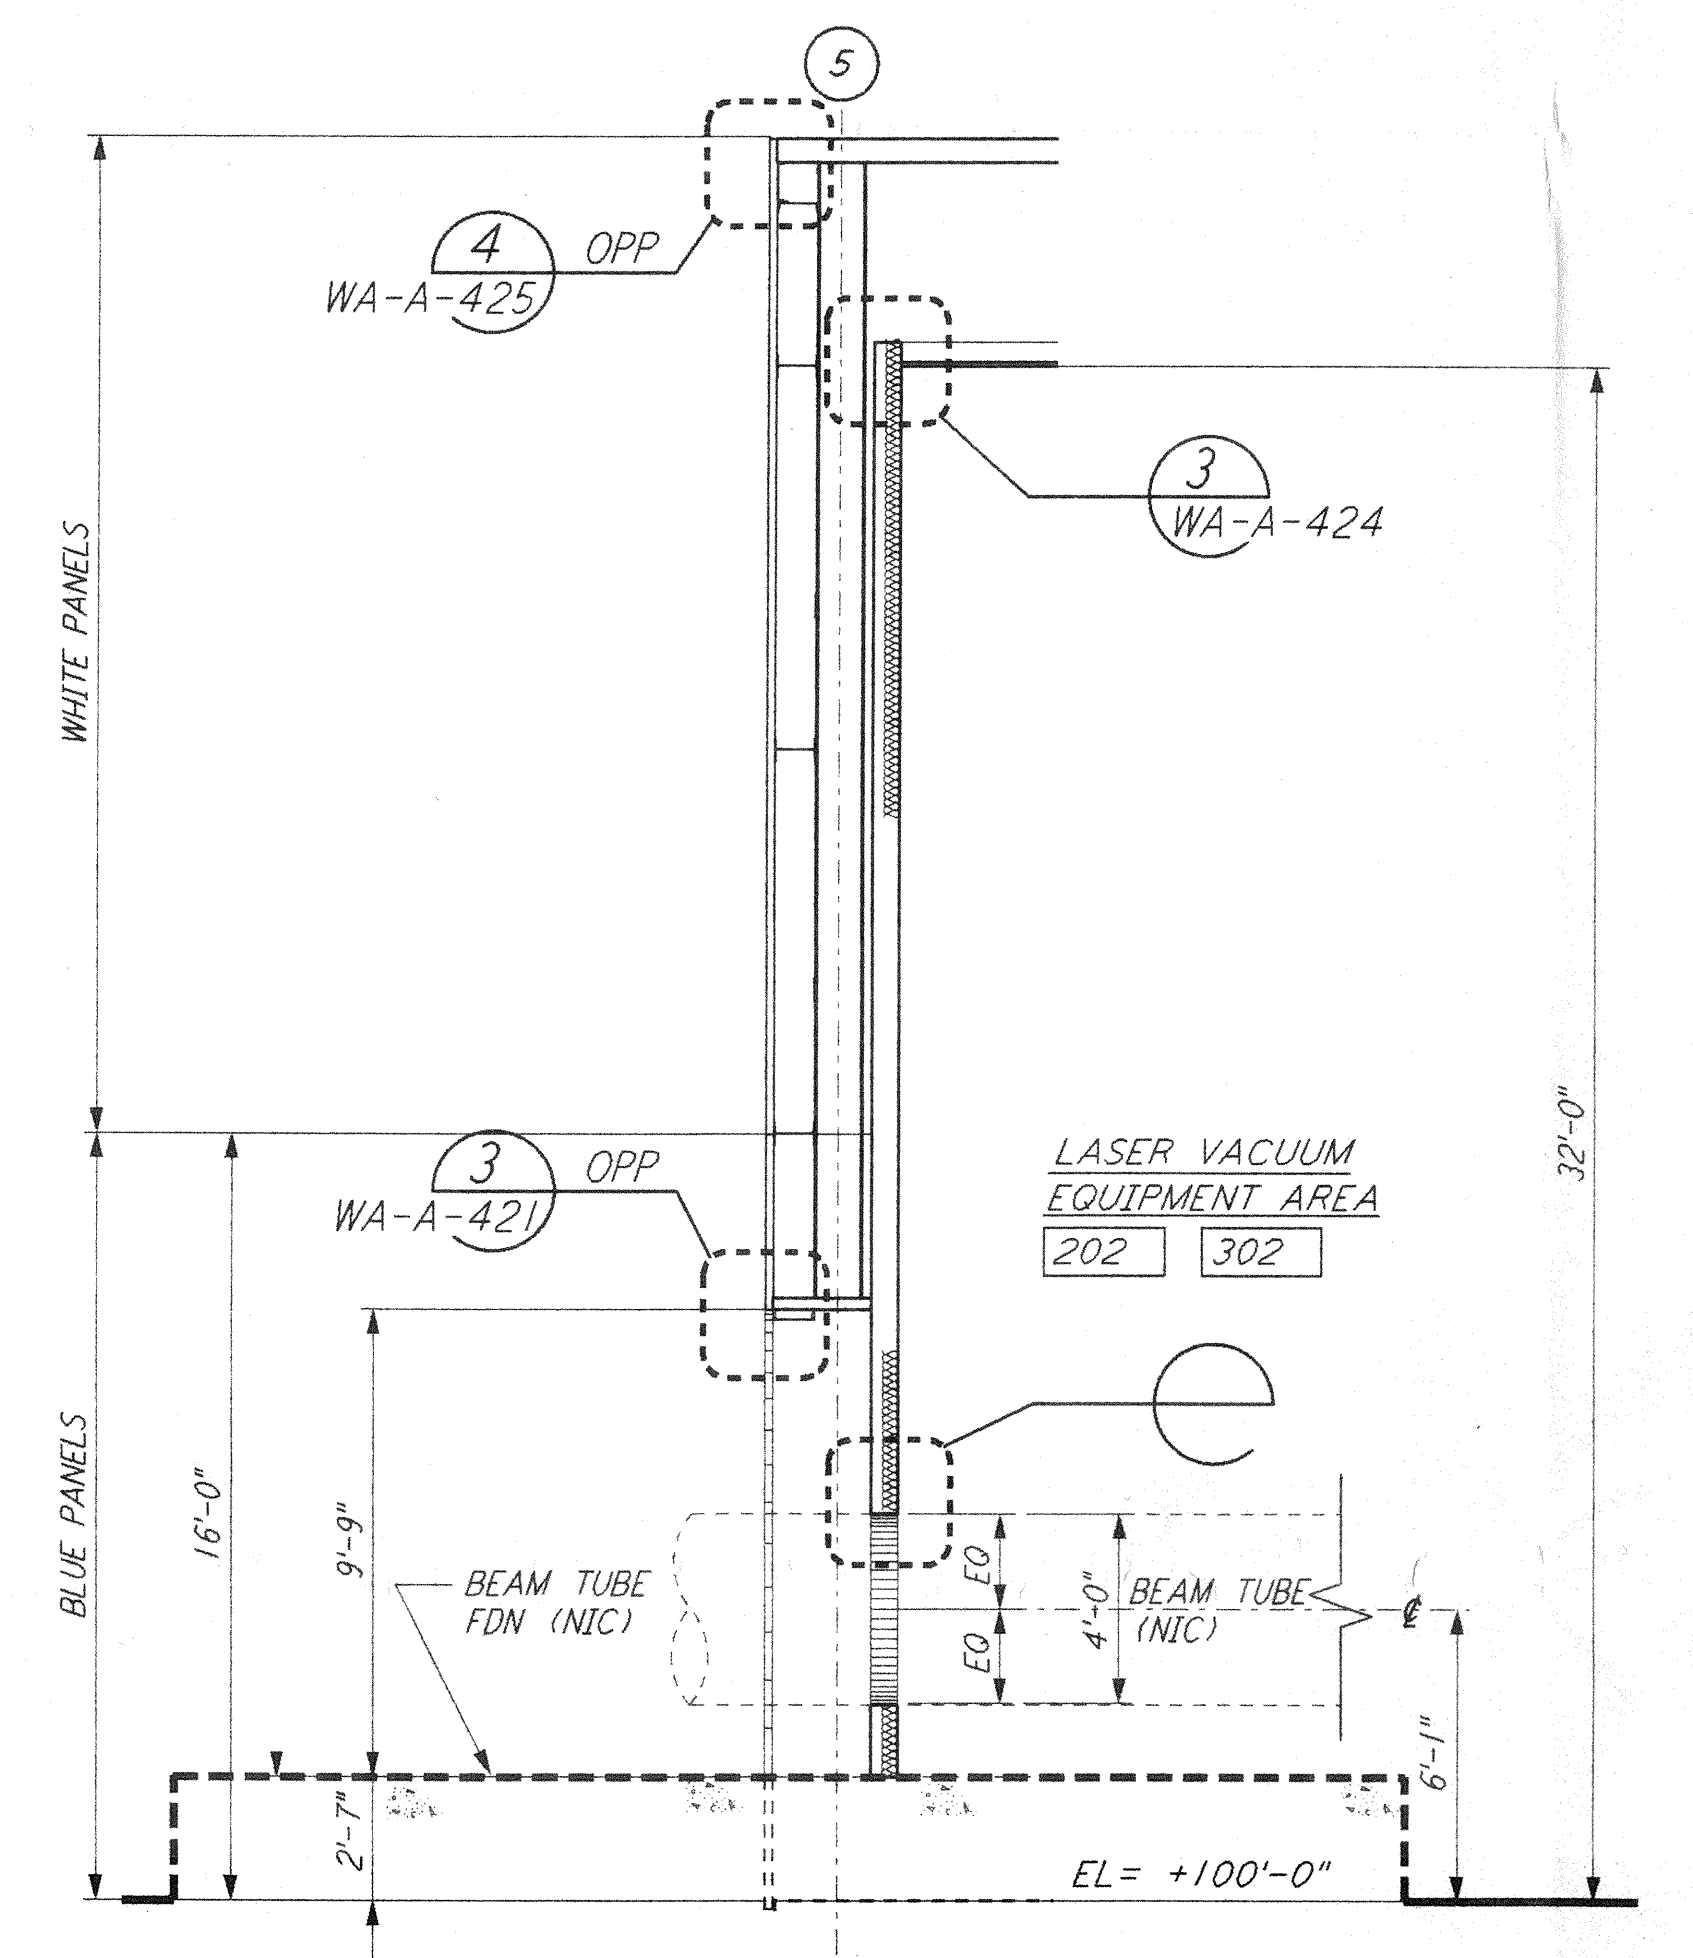


WALL SECTION
 1/4" = 1'-0"
 H REF
 WA-A-261 WA-A-201

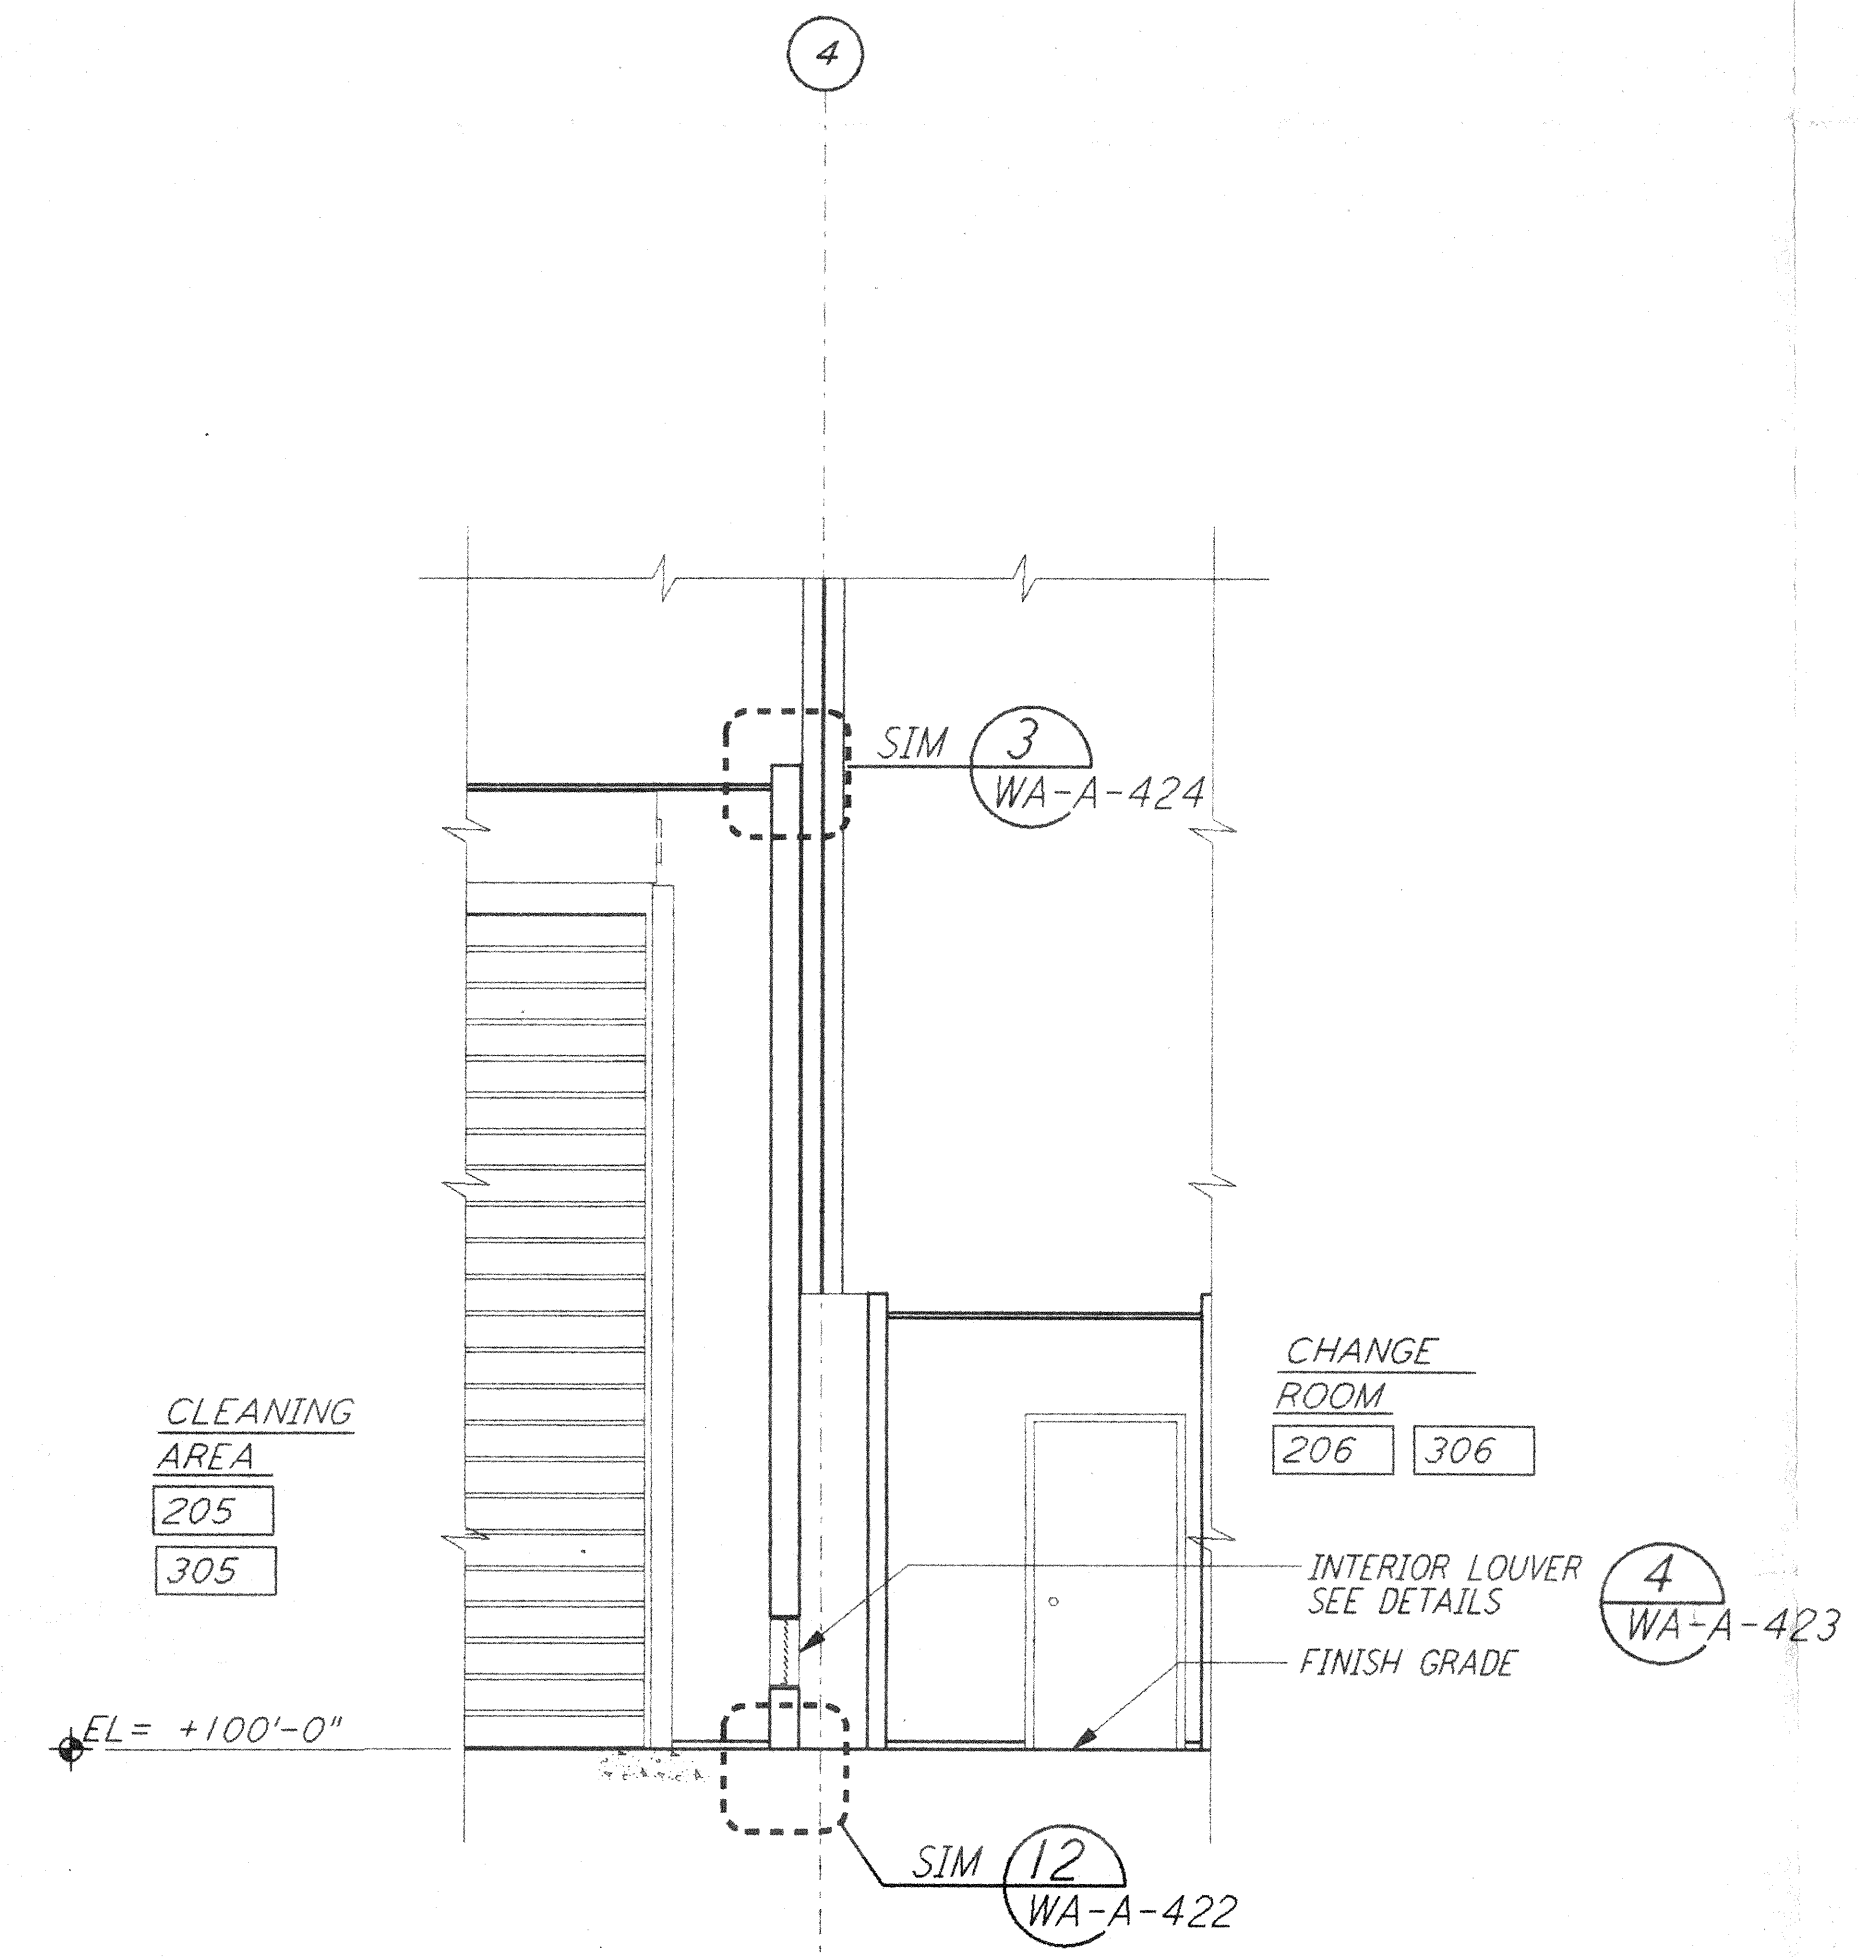

WALL SECTION
 1/4" = 1'-0"
 F REF
 WA-A-261 WA-A-251

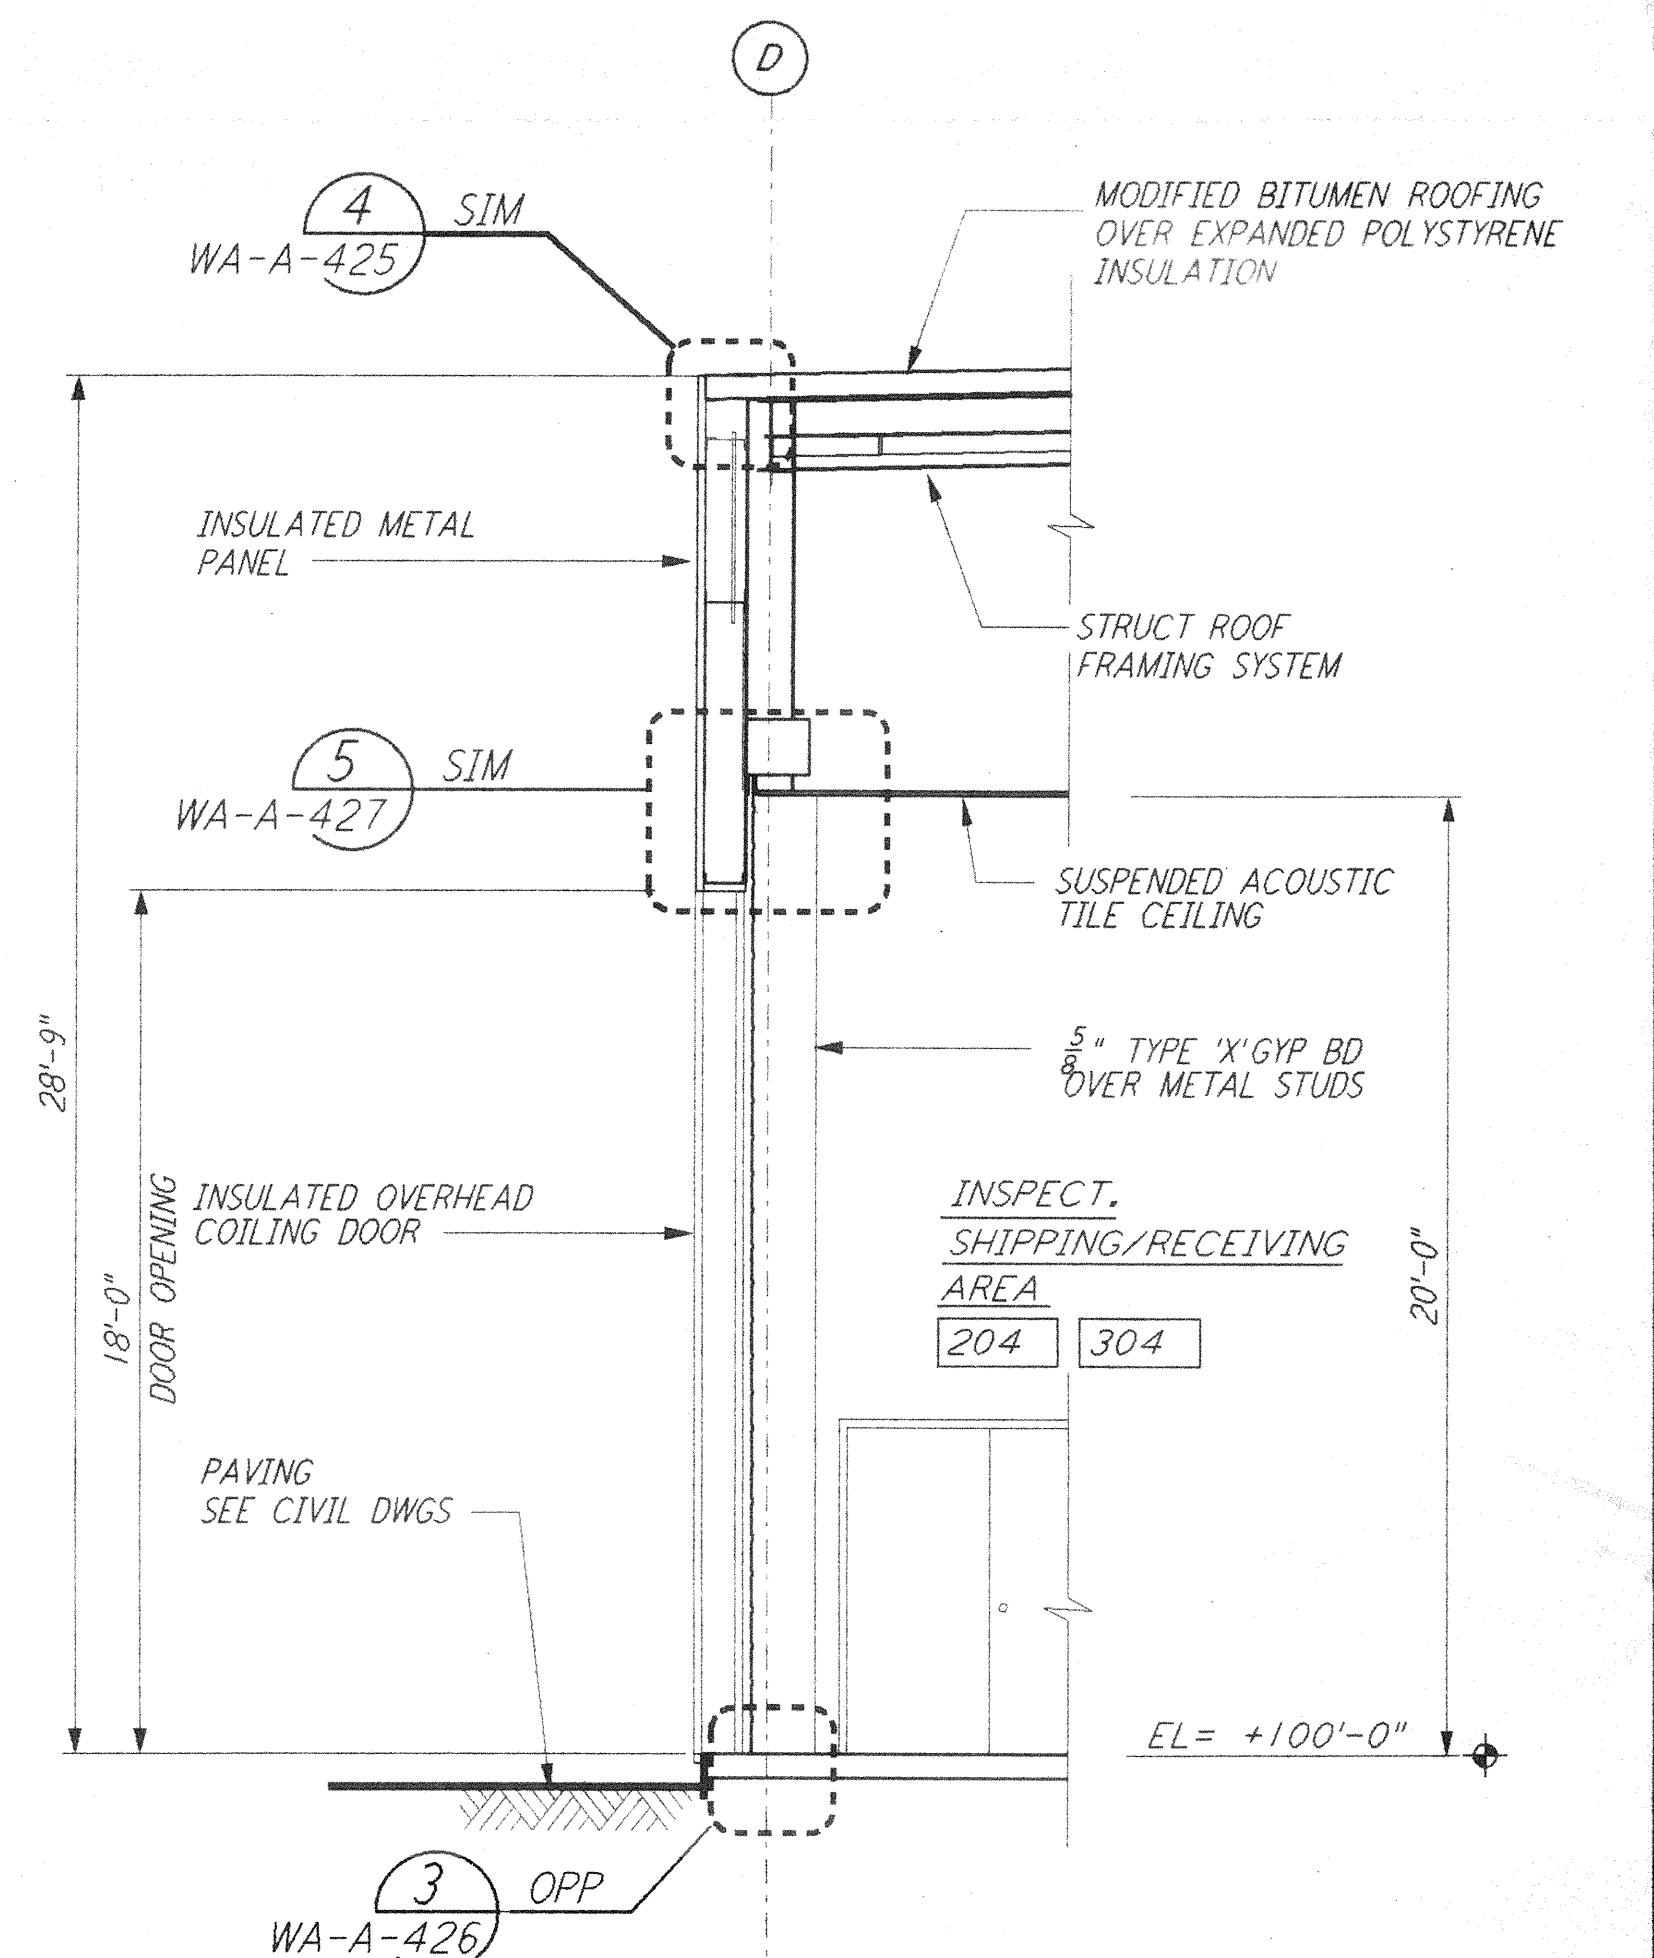

WALL SECTION
 1/4" = 1'-0"
 D REF
 WA-A-261 WA-A-251

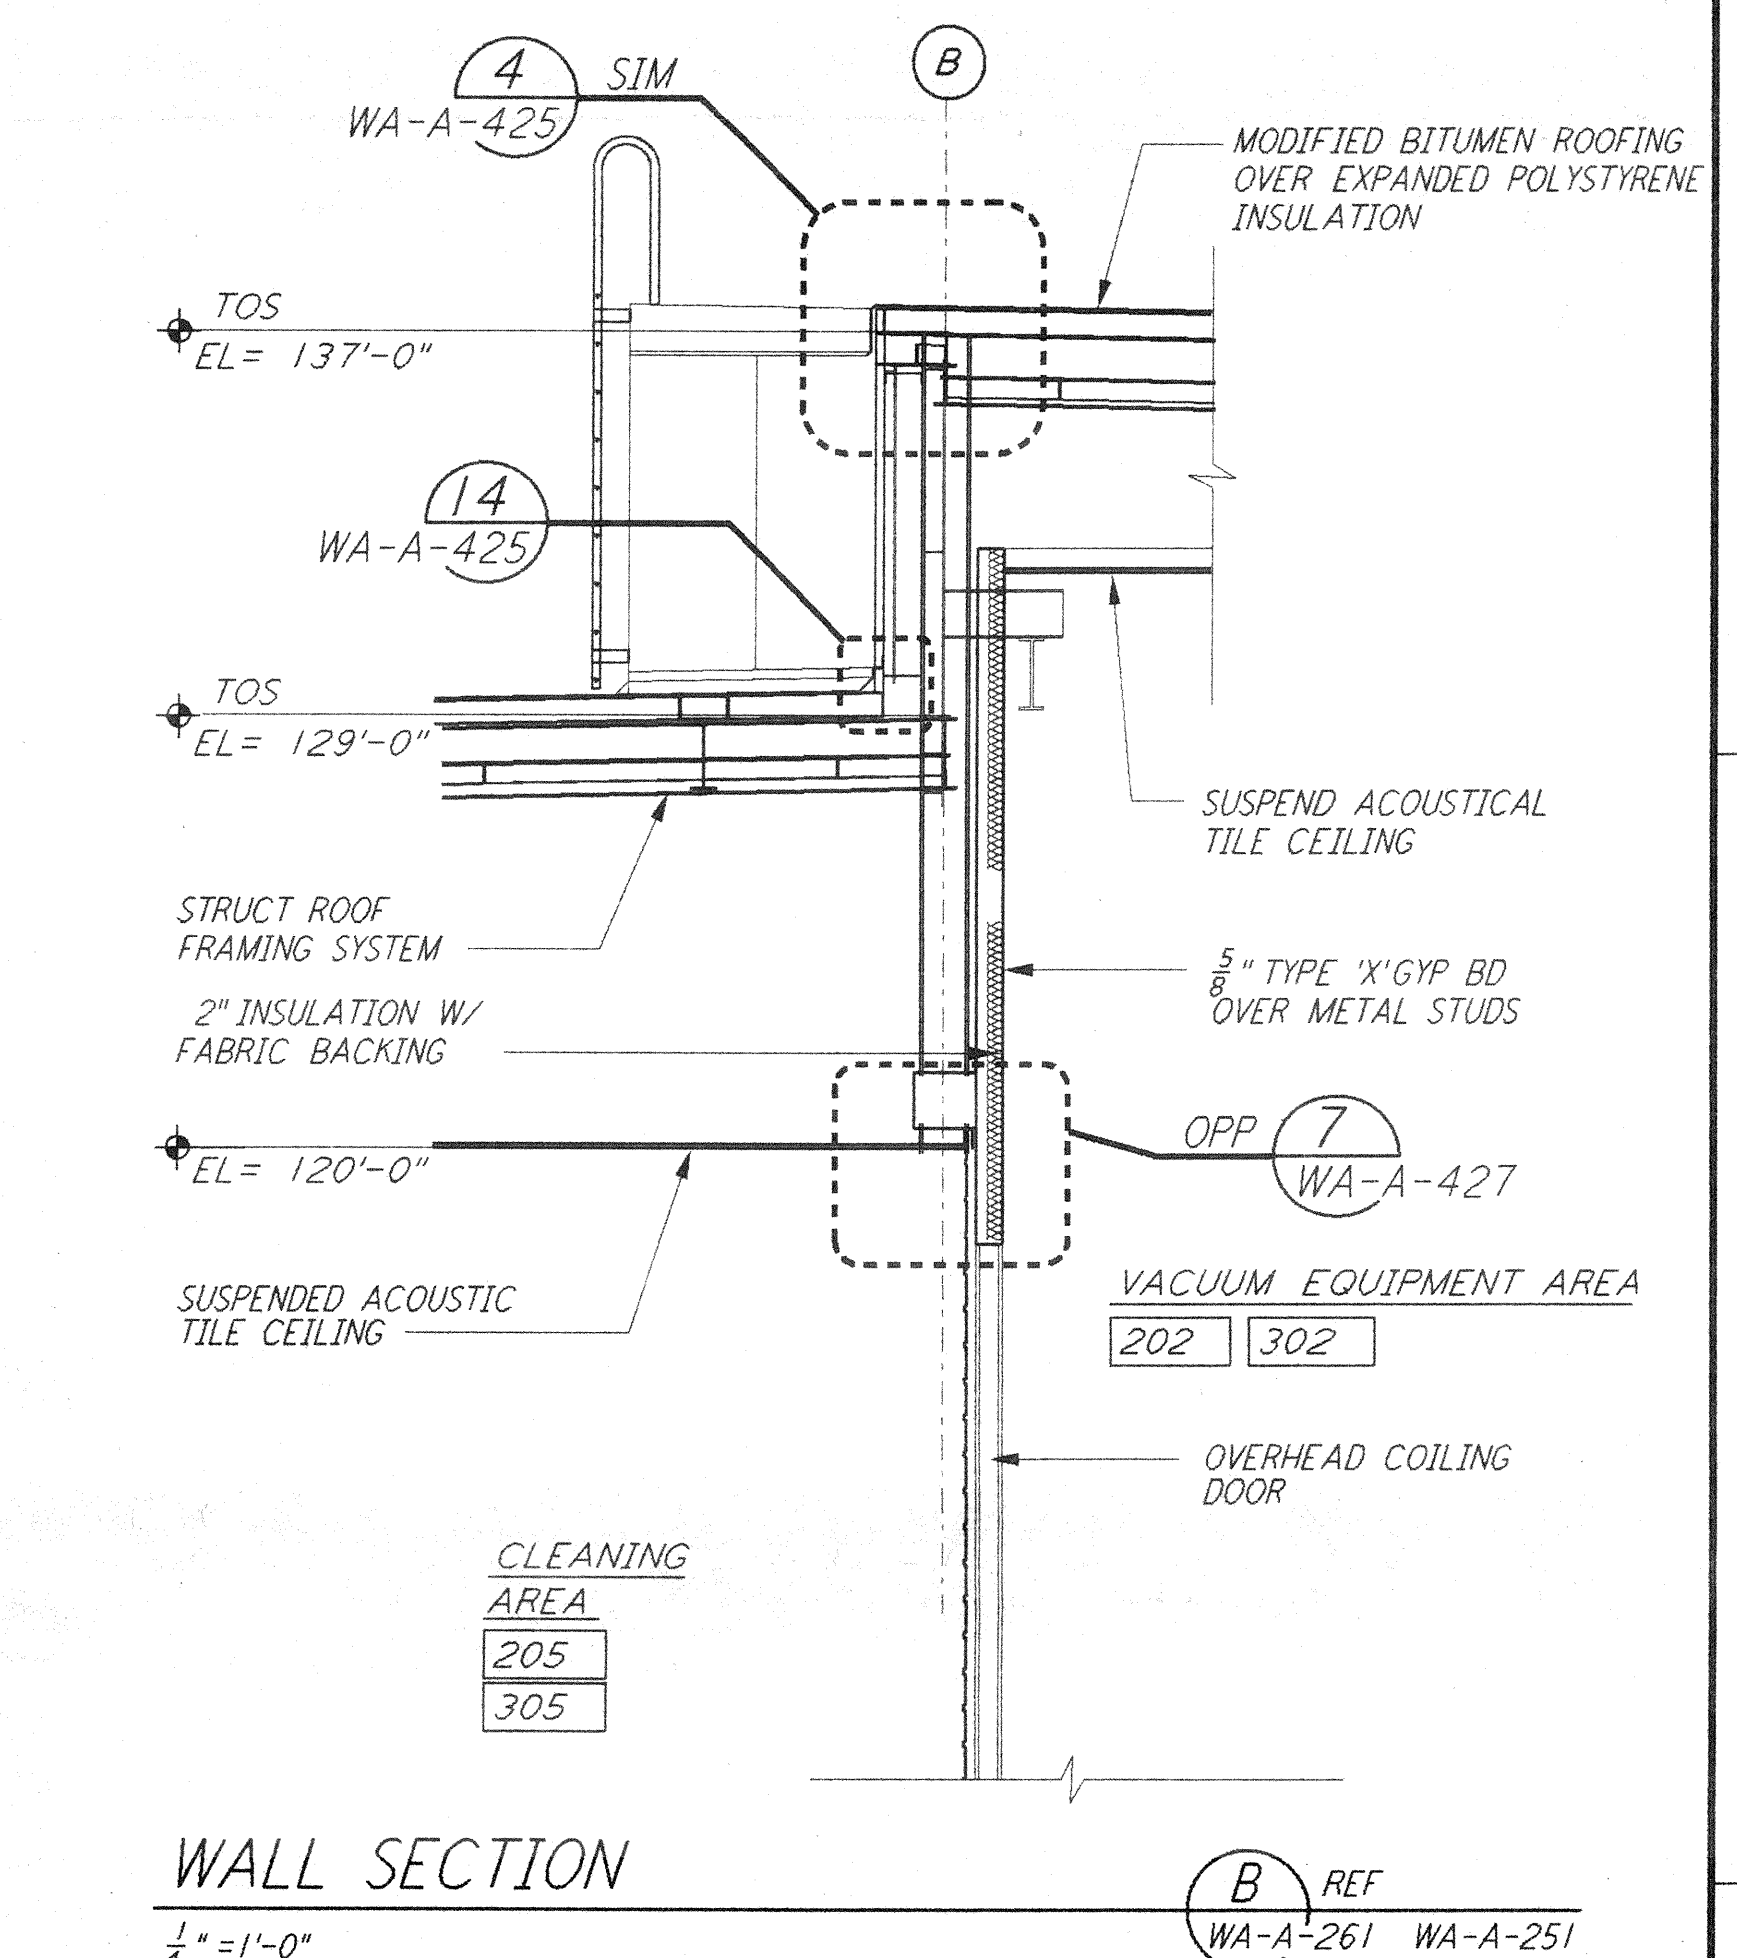

WALL SECTION
 1/4" = 1'-0"
 B REF
 WA-A-261 WA-A-251

0 4 8 12 16 FT
 1/4" = 1'-0"
 DATUM POINT EL +100.00 = 531.11' (LVEA)
 DATUM POINT EL +100.00 = 531.11' (OSB)
 DATUM POINT EL +100.00 = 528.07' (MID NORTH)
 DATUM POINT EL +100.00 = 527.05' (END NORTH)
 DATUM POINT EL +100.00 = 532.22' (MID SOUTH WEST)
 DATUM POINT EL +100.00 = 535.26' (END SOUTH WEST)

| NO. | DATE | BY | CHKD | ENGR | PROJ | DESCRIPTION |
|-----|------|----|------|------|------|-------------|
| | | | | | | |
| | | | | | | |
| | | | | | | |

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|-------------------------|-------------|
| ISSUED FOR CONSTRUCTION | |
| DRAWN | CKT 5-12-96 |
| CHECKED | TB 5-26-96 |
| ENGINEER | KK 7-12-96 |
| PROJ | WAL 7/12/96 |

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LASER INTERFEROMETER
 GRAVITATIONAL-WAVE OBSERVATORY
 SITE NO. 1 - HANFORD, WASHINGTON

TITLE: ARCHITECTURAL MID & END STATIONS WALL SECTIONS
 SHEET NUMBER: WA-A-261
 PROJECT NUMBER: PPI50969 8094