


NOTES:
 1. FOR LEGEND, ABBREVIATIONS AND GENERAL NOTES SEE SHEETS WA-H-001 AND WA-H-002.
 2. SEE FLOOR PLAN NOTES FOR DUCT INSULATION.


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SECTION D REF
 1/4" = 1'-0" (WA-H-153) (WA-H-113)

Date Received: 4/19/96	LIGO-D960359-A-D
Contract # WA-H-153 Rev A	
TIM # 37	LIGO-960857-00-1
Date: 4/19/96	Approved:
TDM #	LIGO:
Date: / /	Approved:
Client Transmittal	LIGO:
Date: / /	Approved:

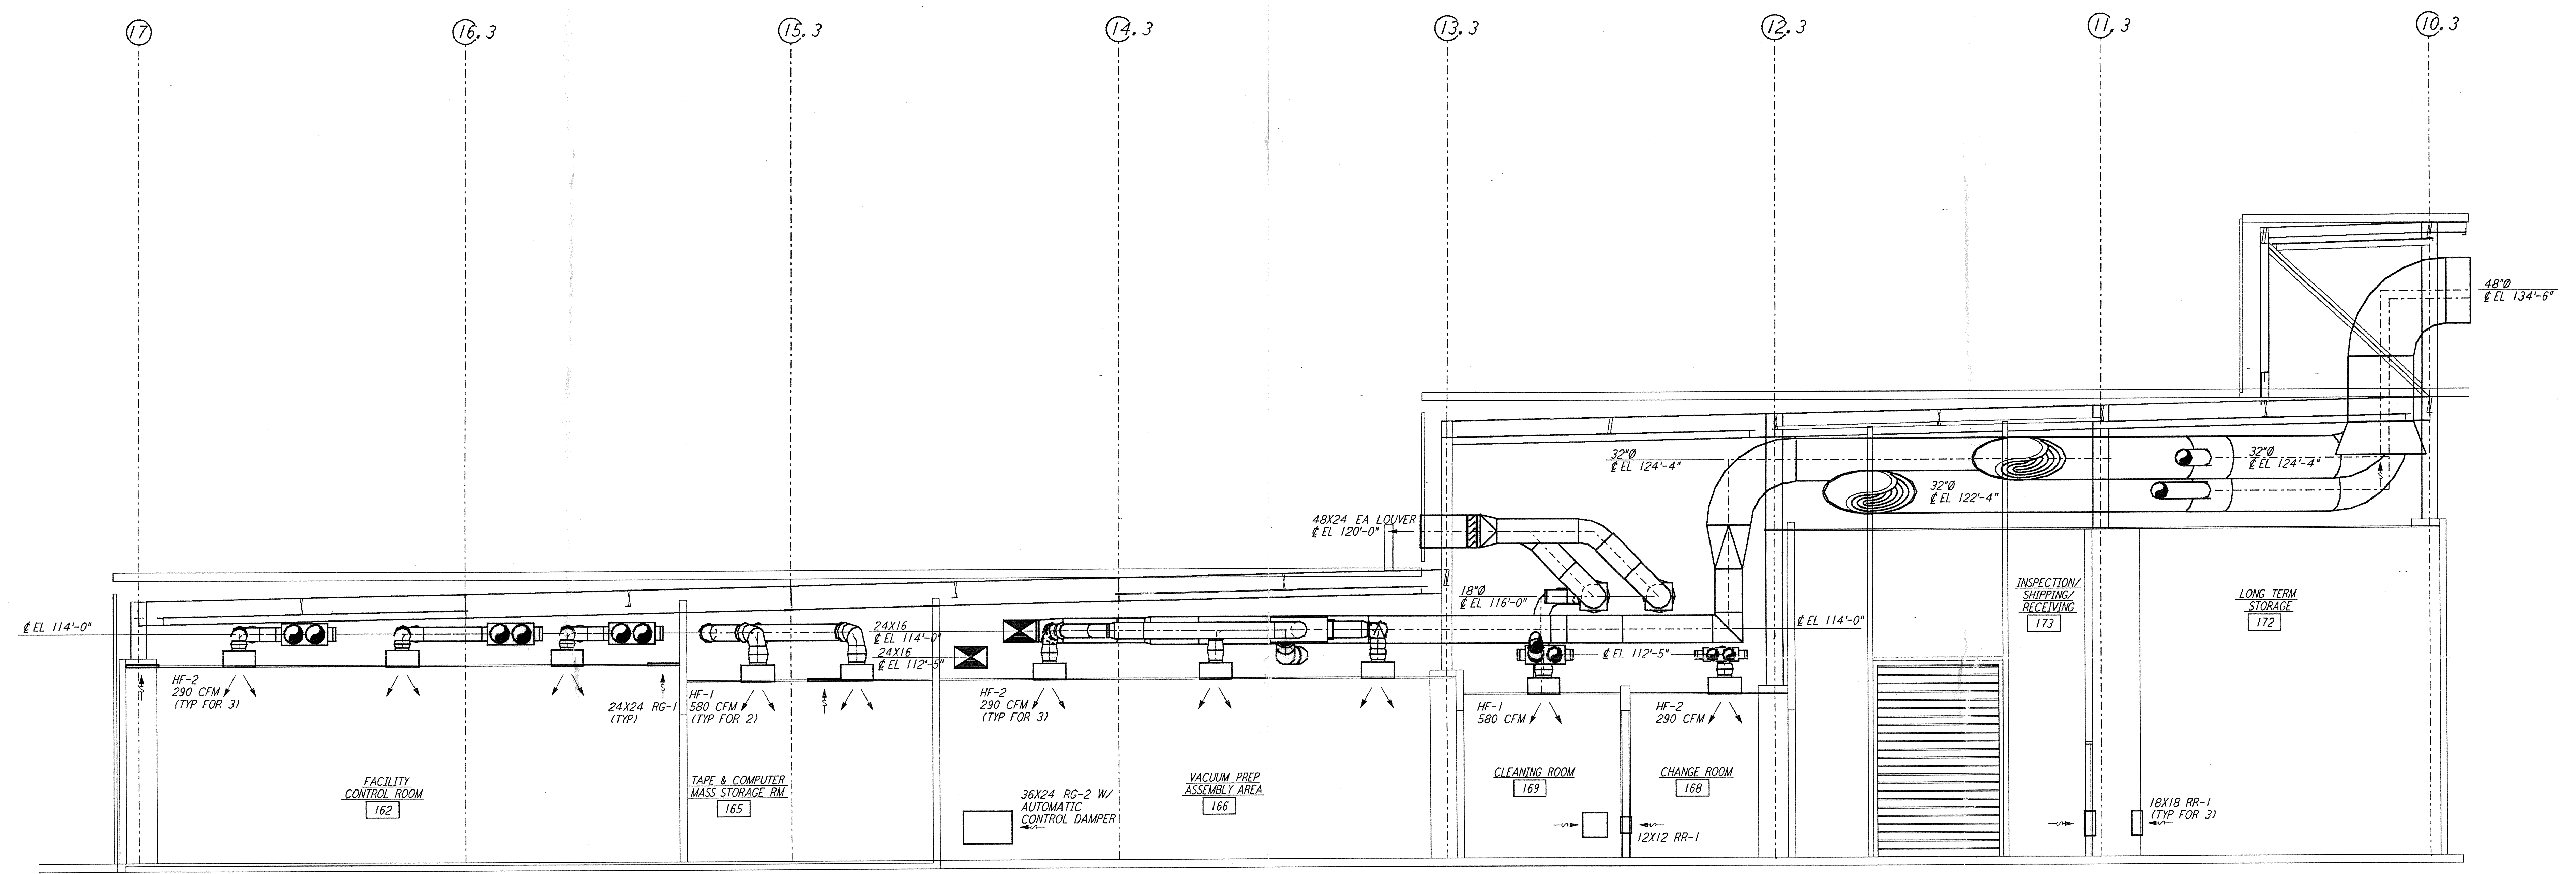

NO.	DATE	BY	CHKD	ENGR	PROJ	DESCRIPTION
A	4-19-96	CLP	ME	AA		FINAL DESIGN REVIEW & BID

DRAWN	CLP
CHECKED	
ENGINEER	
PROJ	
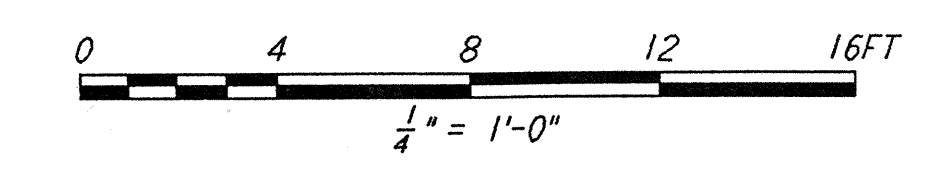
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LASER INTERFEROMETER
 GRAVITATIONAL-WAVE OBSERVATORY
 SITE NO. 1 - HANFORD, WASHINGTON

HVAC
 CORNER STATION
 SECTIONS SHEET 3

SCALE: AS NOTED
 CONTRACT NUMBER: PPI50969
 PROJECT NUMBER: 8094

SHEET NUMBER: **WA-H-153**