




LIGHTING PLAN

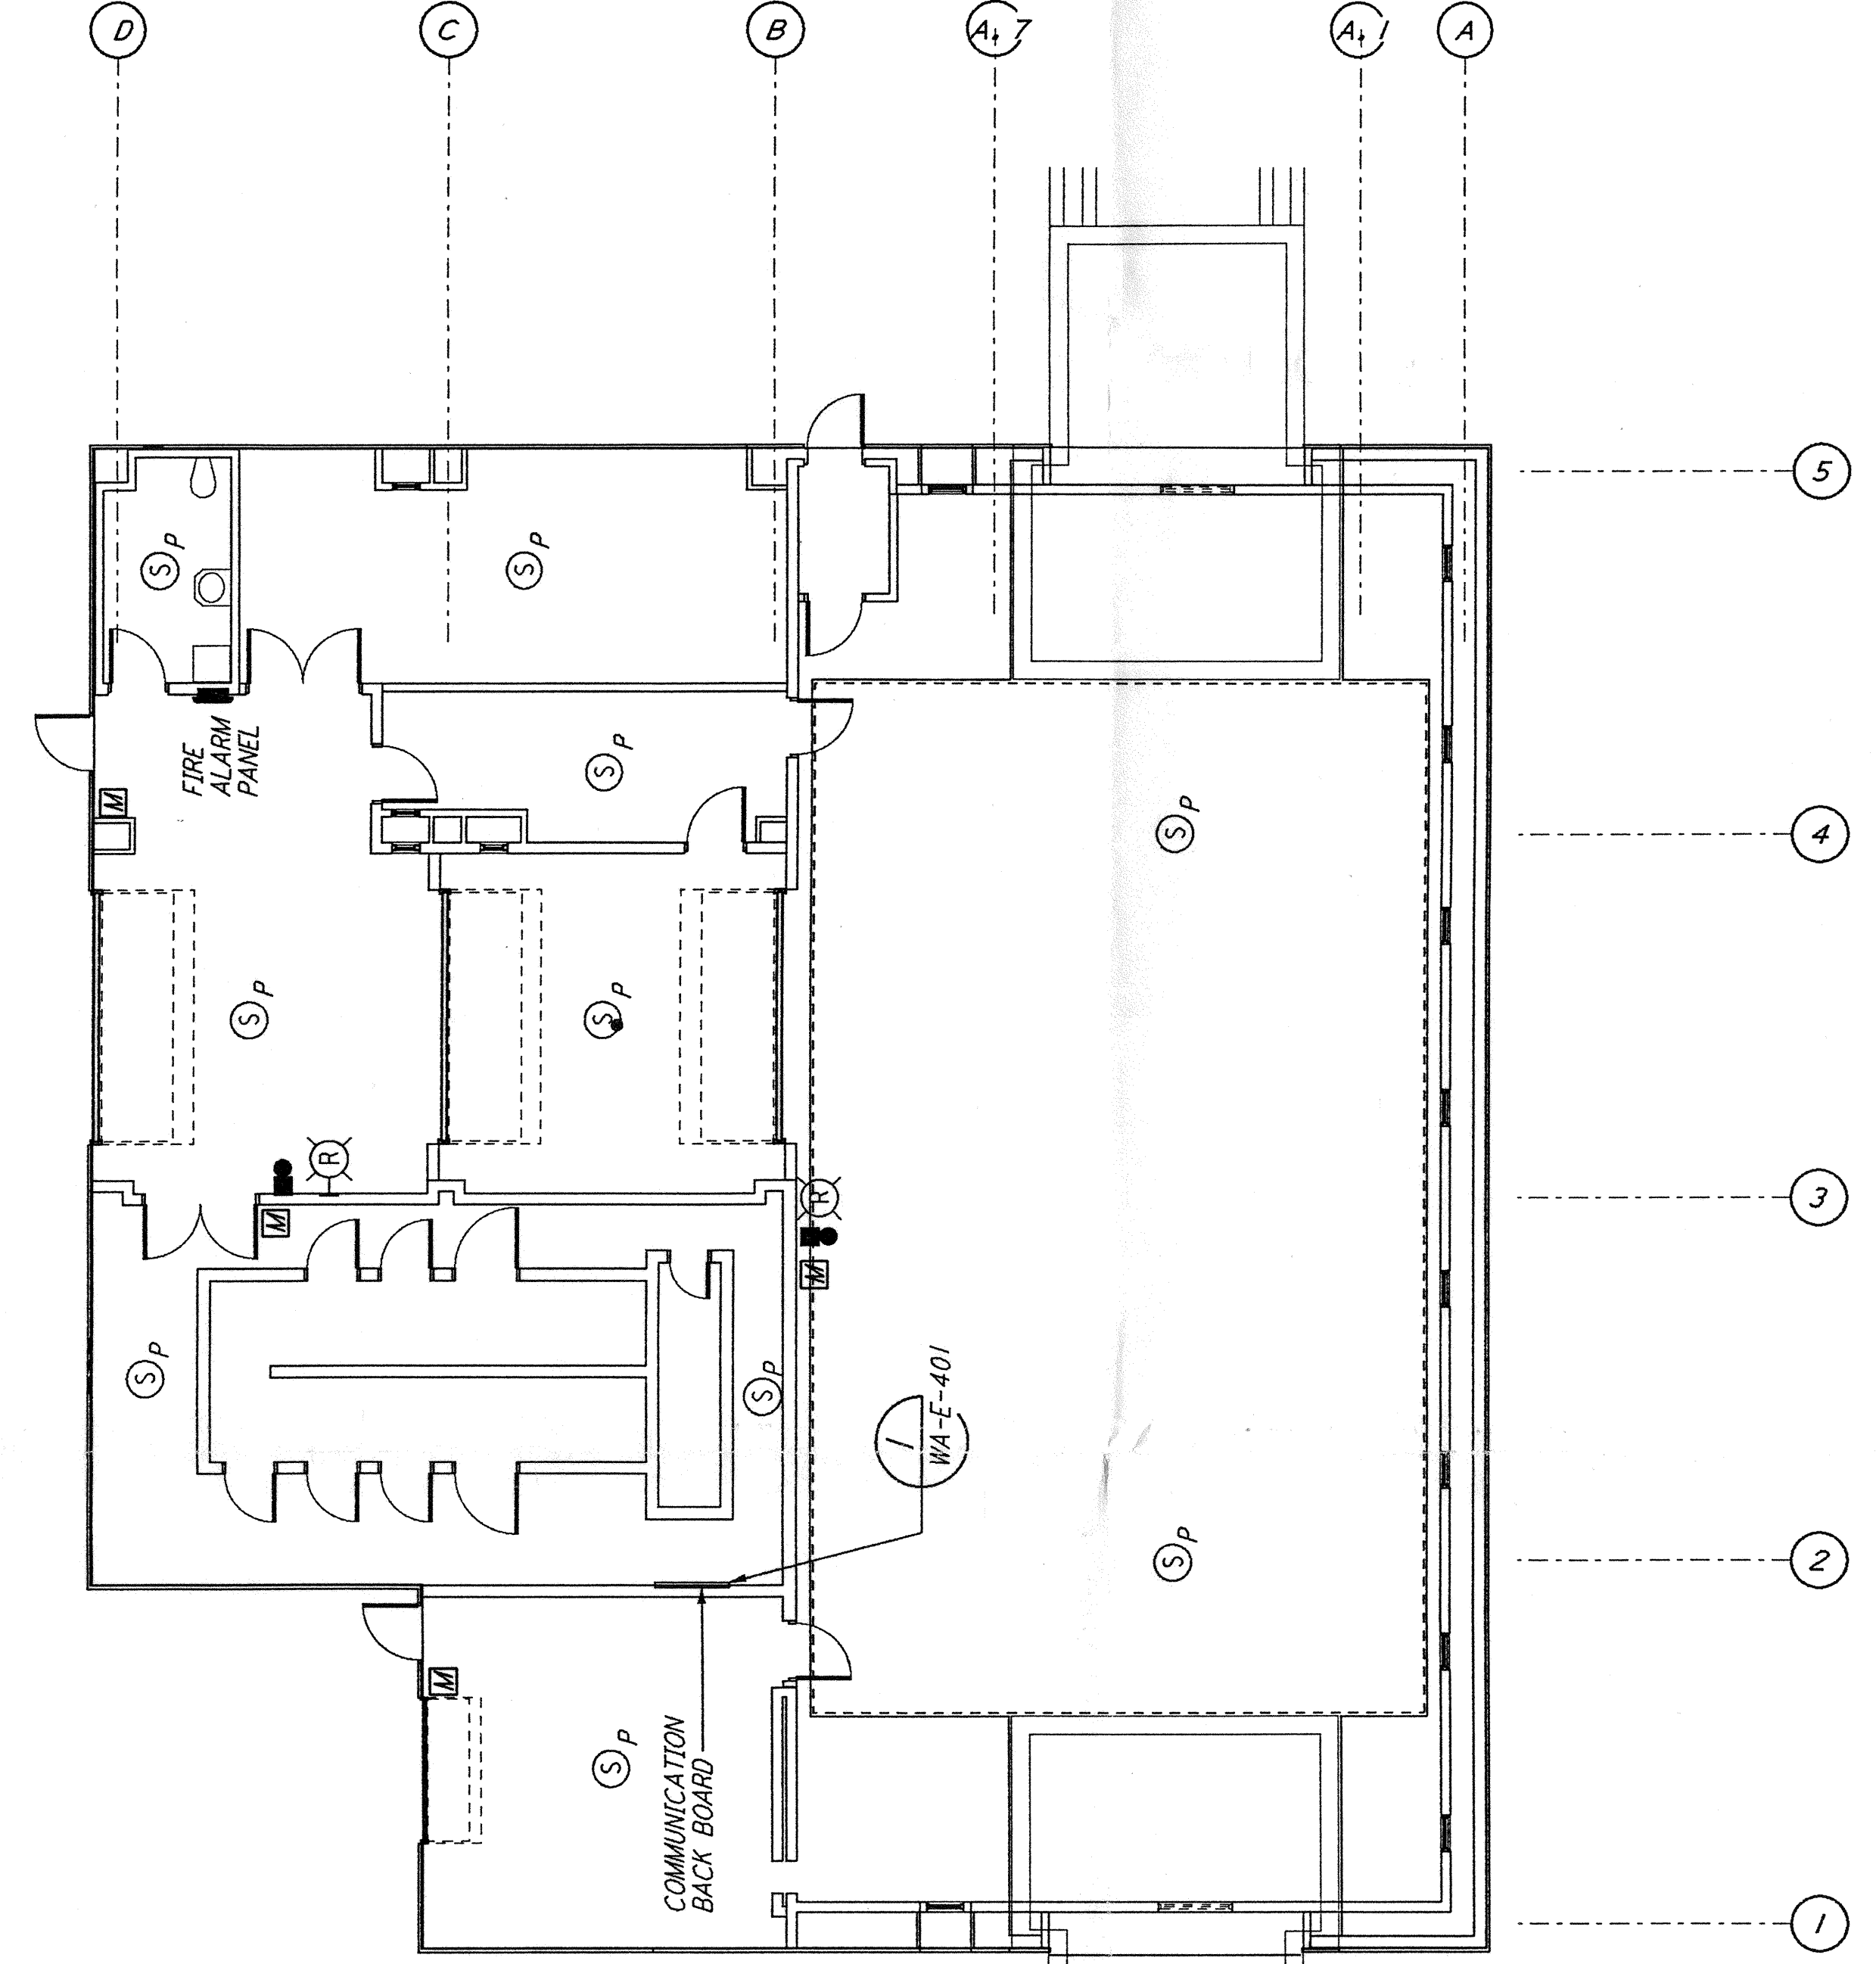

COMMUNICATIONS AND FIRE DETECTION PLAN

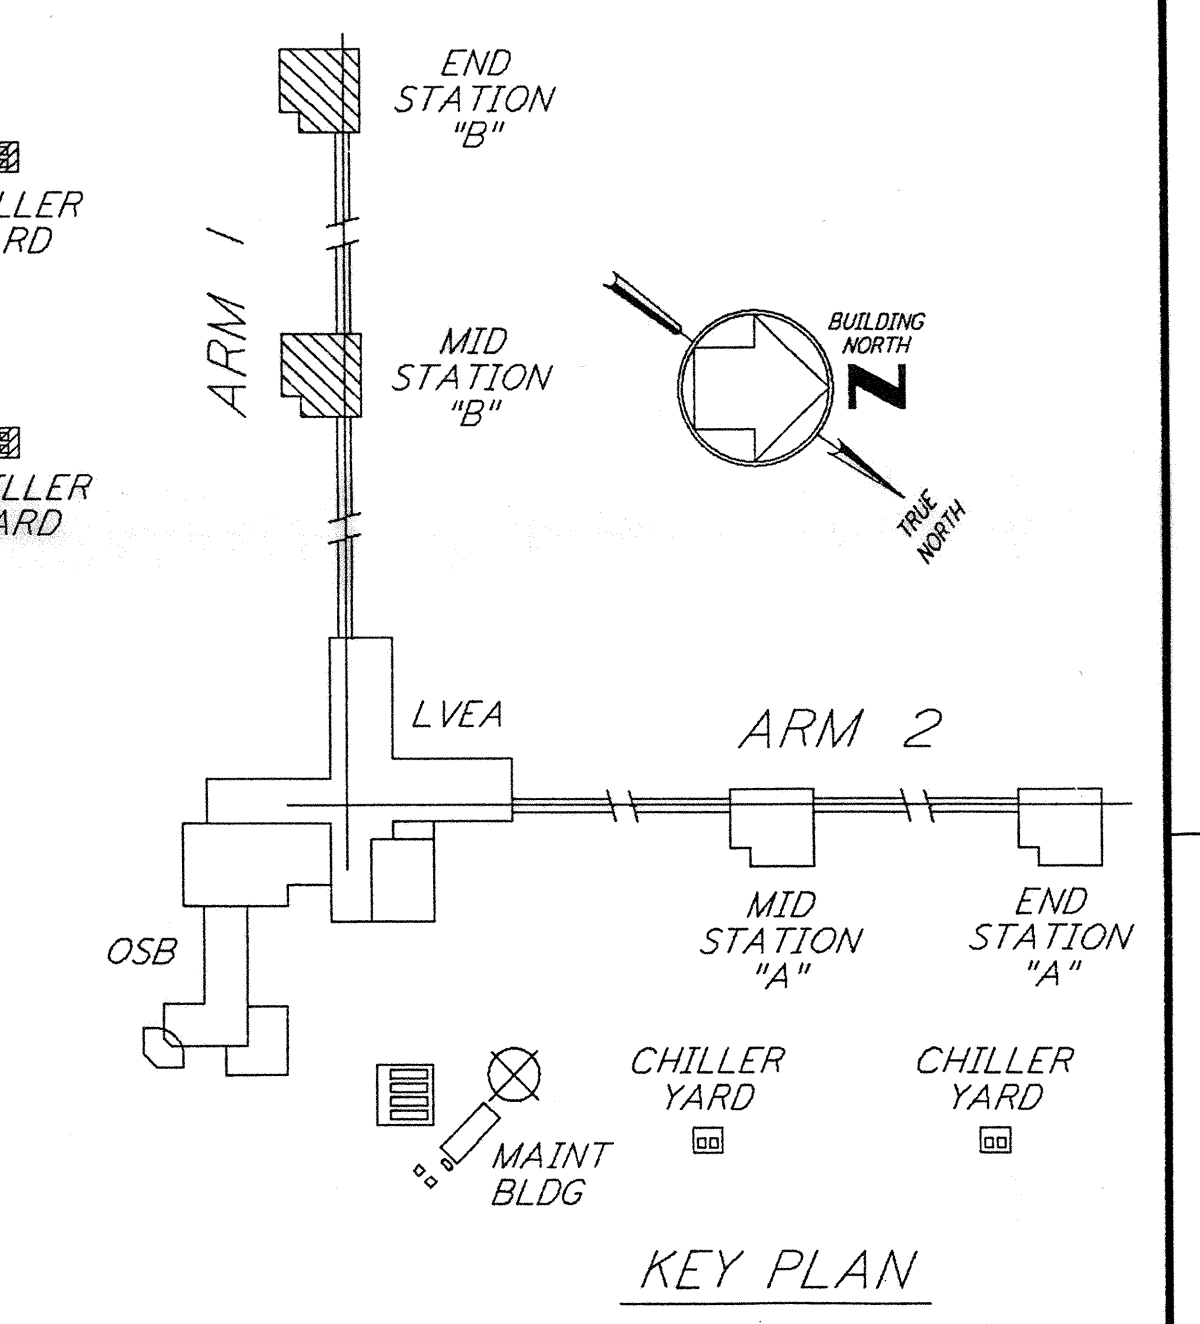

KEY PLAN

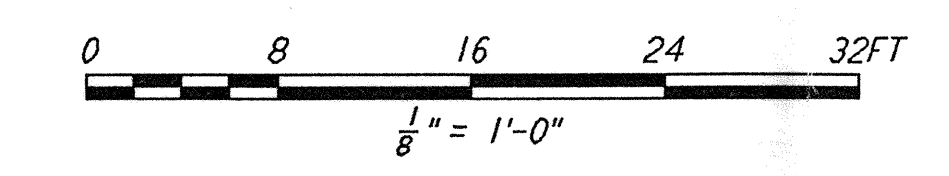

NOTES:

1. FOR GENERAL NOTES SEE DRAWINGS WA-E-102.
2. ALL CIRCUITS SHOWN ON THIS DRAWING ARE FROM PANEL DP-02 UNLESS OTHERWISE NOTED.
3. FOR PANEL SCHEDULES SEE DRAWING WA-E-205 AND WA-E-206.
4. FOR FIXTURE LOCATION SEE ARCHITECTURAL REFLECTED CEILING PLAN ON DRAWING WA-A-221.
5. FOR FIRE DETECTION NOTES SEE DRAWING WA-E-110.

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NO.	DATE	BY	CHKD	ENGR	PROJ	DESCRIPTION
A	4-19-96	MM	YL	JDM		FINAL DESIGN REVIEW & BID

DRAWN	M. M.
CHECKED	
ENGINEER	
PROJ	

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LASER INTERFEROMETER
 GRAVITATIONAL-WAVE OBSERVATORY
 SITE NO. 1 - HANFORD, WASHINGTON

TITLE: **ELECTRICAL
 MID & END B STATIONS
 LIGHTING, COMMUNICATIONS
 & FIRE DETECTION PLAN**

SCALE: AS NOTED
 SHEET NUMBER: **WA-E-211**

CONTRACT NUMBER: PP150969
 PROJECT NUMBER: 8094

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