



**NOTES:**

1. SEE SHEET LA-C-002 FOR GENERAL NOTES, LEGEND AND ABBREVIATIONS.
2. SEE SHEET LA-C-004 FOR TYPICAL SECTIONS AND DETAILS.

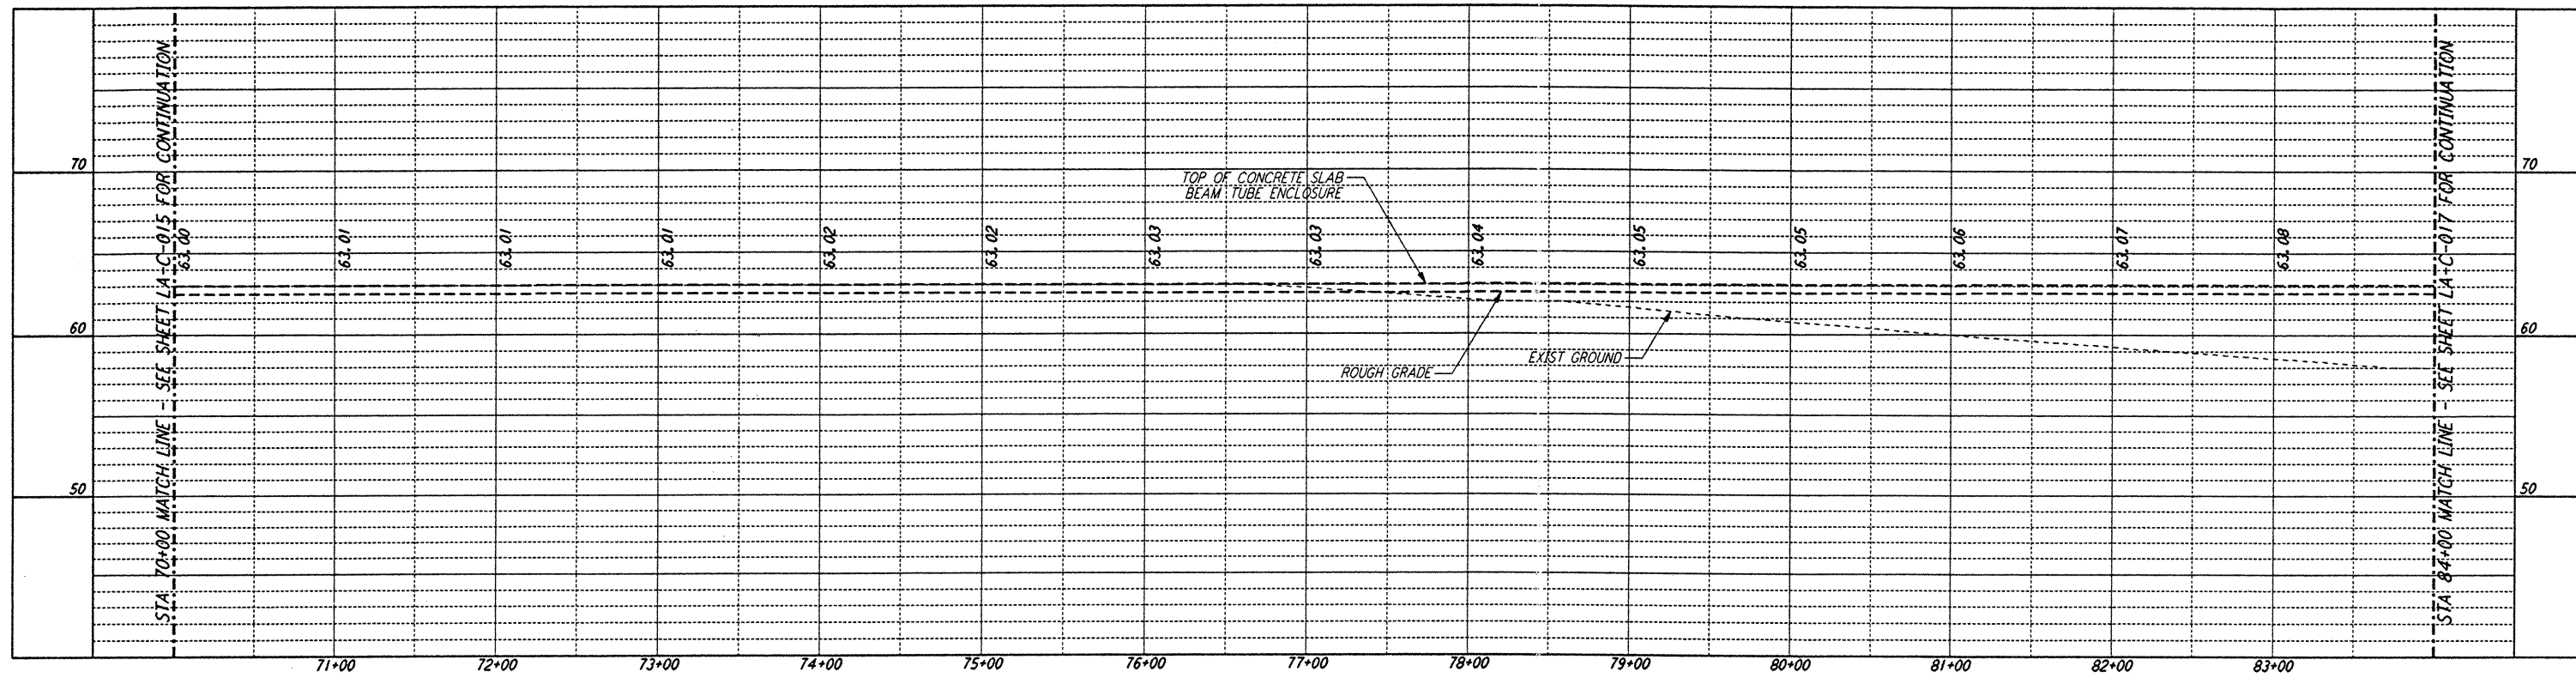


**PROFILE**

SCALES: HORIZ: 1" = 50'  
 VERT: 1" = 5'

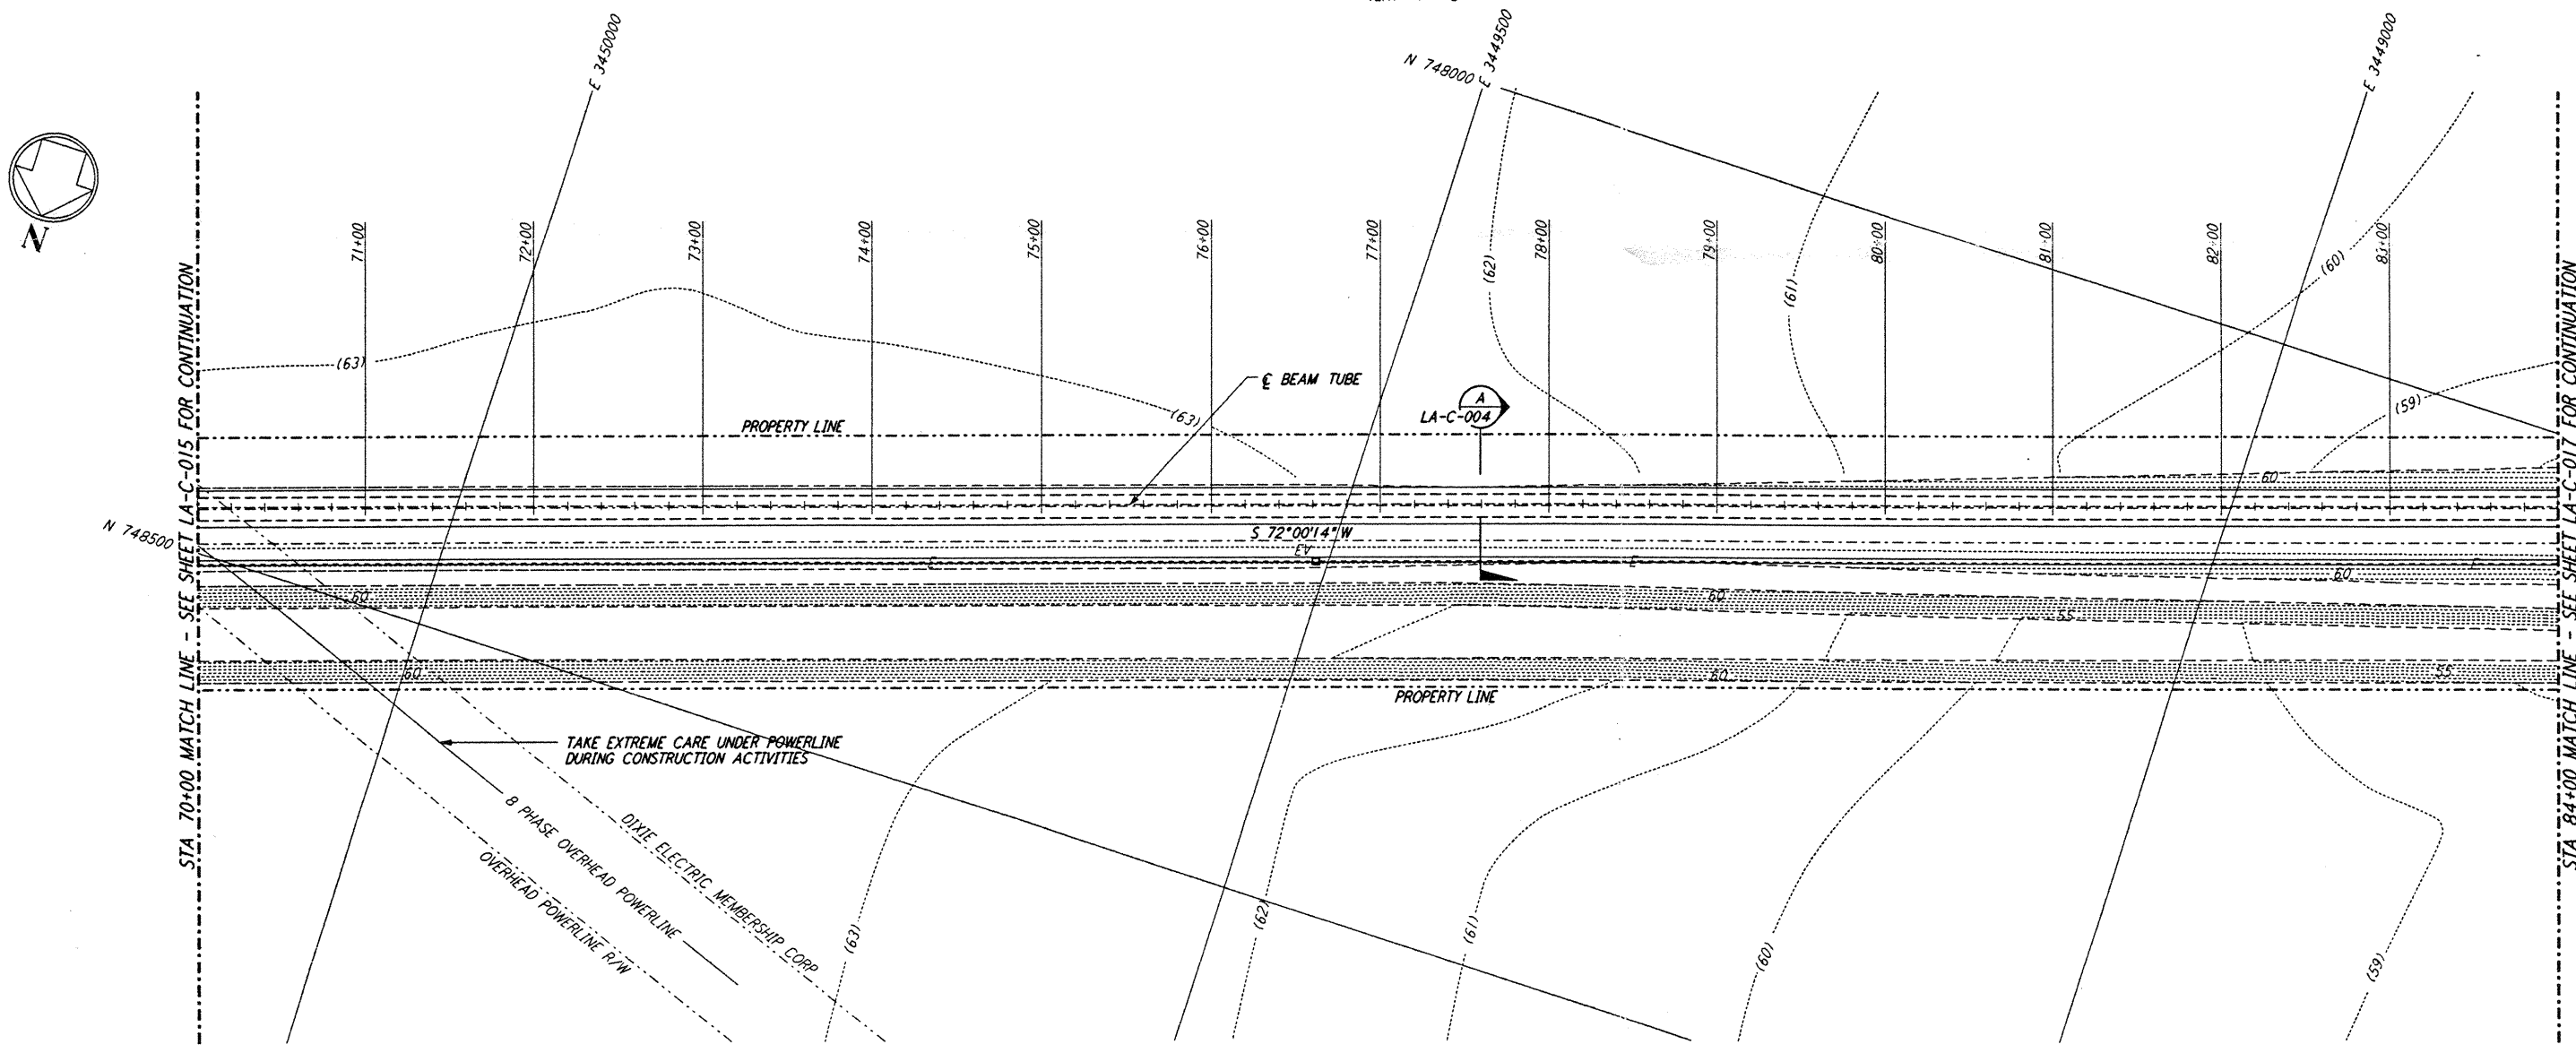


**PLAN**

SCALE: 1" = 50'

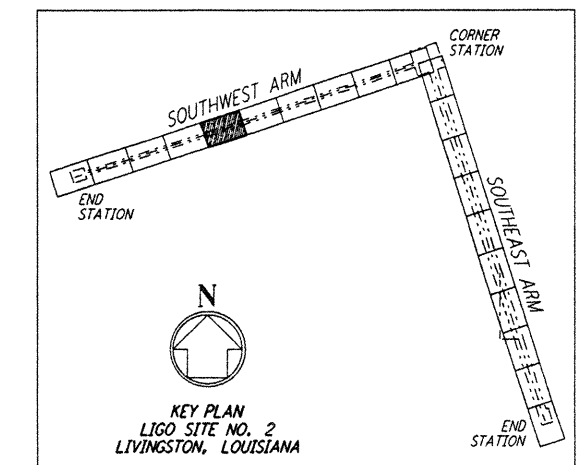

KEY PLAN  
 LIGO SITE NO. 2  
 LIVINGSTON, LOUISIANA

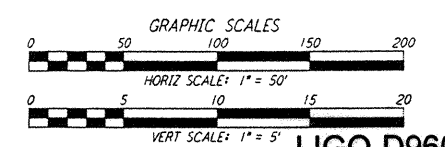

LIGO-D960834-A-0

LASER INTERFEROMETER  
 GRAVITATIONAL-WAVE OBSERVATORY  
 SITE NO. 2 - LIVINGSTON, LOUISIANA

TITLE: CIVIL  
 SCALE: AS NOTED  
 CONTRACT NUMBER: PP150969  
 PROJECT NUMBER: 8094

SOUTHWEST ARM  
 PLAN AND PROFILE  
 STA 70+00 TO STA 84+00

SHEET NUMBER: LA-C-016

**PARSONS**

100 WEST WALNUT STREET  
 PASADENA, CALIFORNIA

**LIGO**

CALIFORNIA INSTITUTE OF TECHNOLOGY  
 MASSACHUSETTS INSTITUTE OF TECHNOLOGY

DRAWN	WRB
CHECKED	
ENGINEER	
PROJ	

NO.	DATE	BY	CHKD	ENGR	PROJ	DESCRIPTION
A	6/14/96	WRB				FINAL DESIGN REVIEW

This document and the design it covers are the property of PARSONS. They are loaned only with the borrower's expressed written agreement that they will not be reproduced, copied, loaned, exhibited, or used in any other way, except by written consent from PARSONS to the borrower.

W00 JUN 13 2:58:21 PM '96 5374280Z 05VLU151506LES3V3BKALENDH04RTR

068 JUN 14 10:58:11 PM '96 5374280Z 05VLU151506LES3V3BKALENDH04RTR