
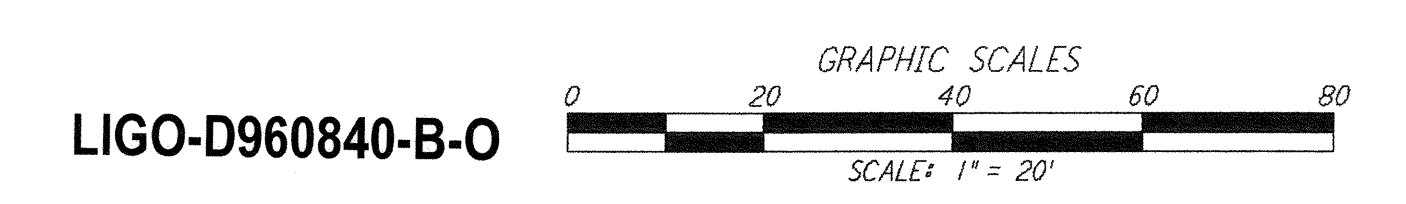
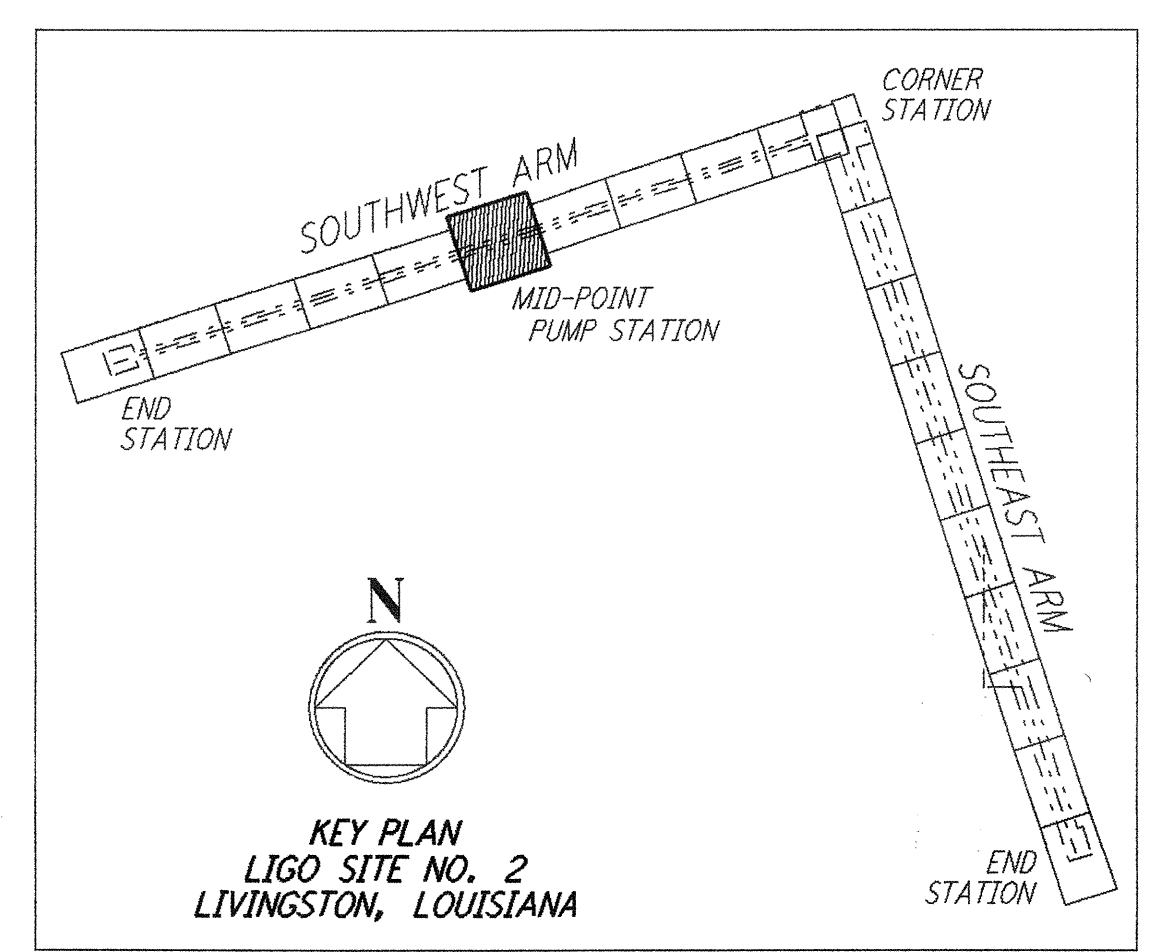
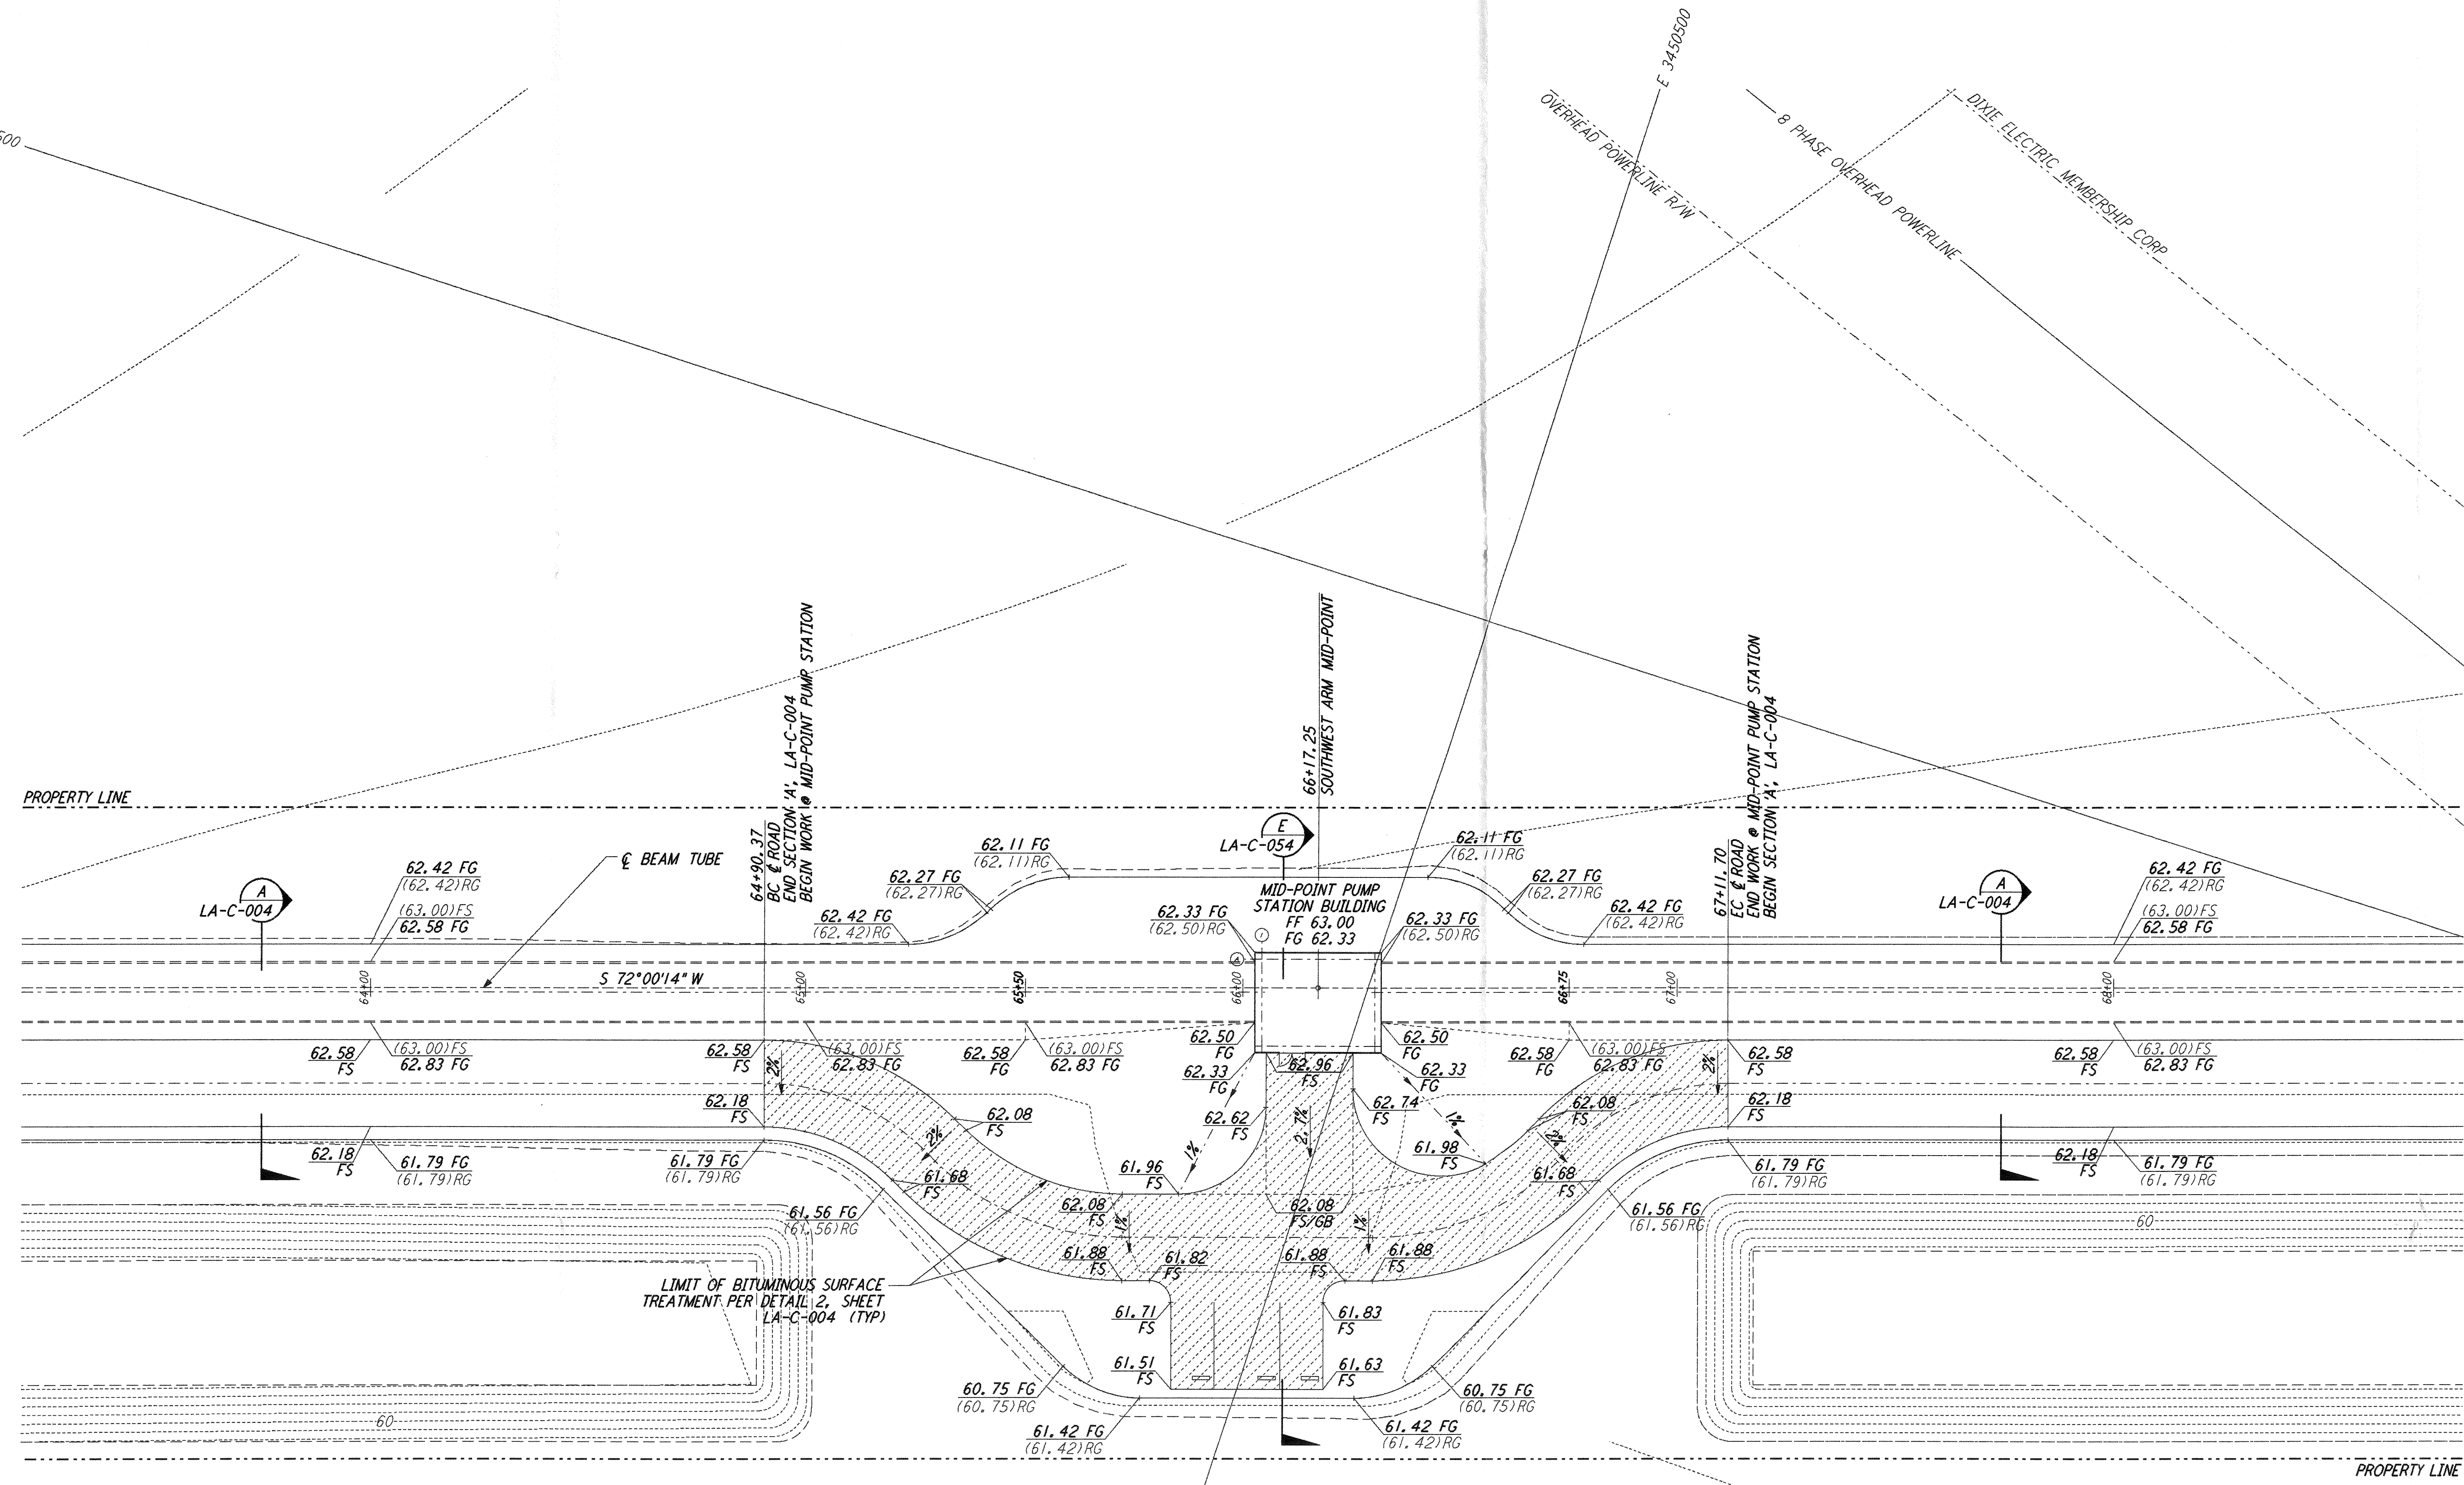


NOTES:  
 1. SEE SHEET LA-C-002 FOR GENERAL NOTES, LEGEND AND ABBREVIATIONS.

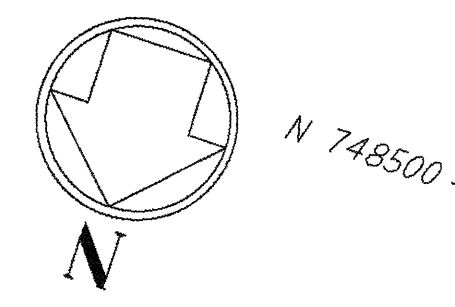

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NO.	DATE	BY	CHKD	ENGR	PROJ	DESCRIPTION
B	7/24/96	WRB	ML		ZJM	ISSUED FOR BID
A	6/14/96	WRB	ML		TDM	FINAL DESIGN REVIEW

DRAWN	WRB
CHECKED	
ENGINEER	
PROJ	

**PARSONS**  
 100 WEST WALNUT STREET  
 PASADENA, CALIFORNIA

**LIGO**  
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 MASSACHUSETTS INSTITUTE OF TECHNOLOGY

LASER INTERFEROMETER  
 GRAVITATIONAL-WAVE OBSERVATORY  
 SITE NO. 2 - LIVINGSTON, LOUISIANA

TITLE	CIVIL SOUTHWEST ARM PUMP STATION GRADING PLAN
SCALE	1" = 20'
CONTRACT NUMBER	PP150969
PROJECT NUMBER	8094
SHEET NUMBER	<b>LA-C-022</b>

MON JUL 22 10:56:53 AM '96 C:\LIGO\SITE2\CE\LA022.DWG

MON JUL 22 10:56:53 AM '96 C:\LIGO\SITE2\CE\LA022.DWG