
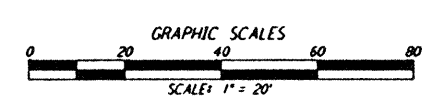
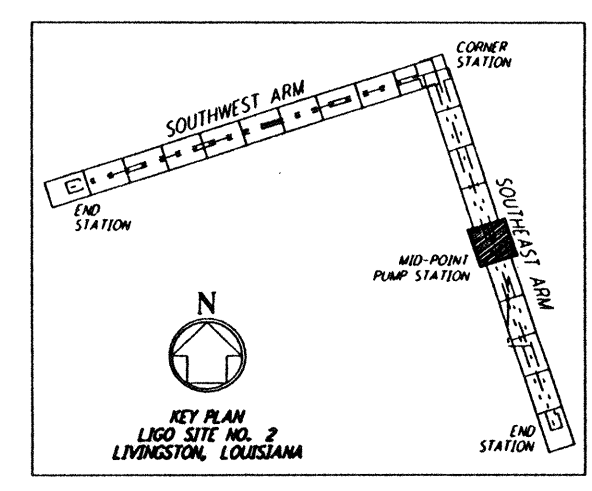
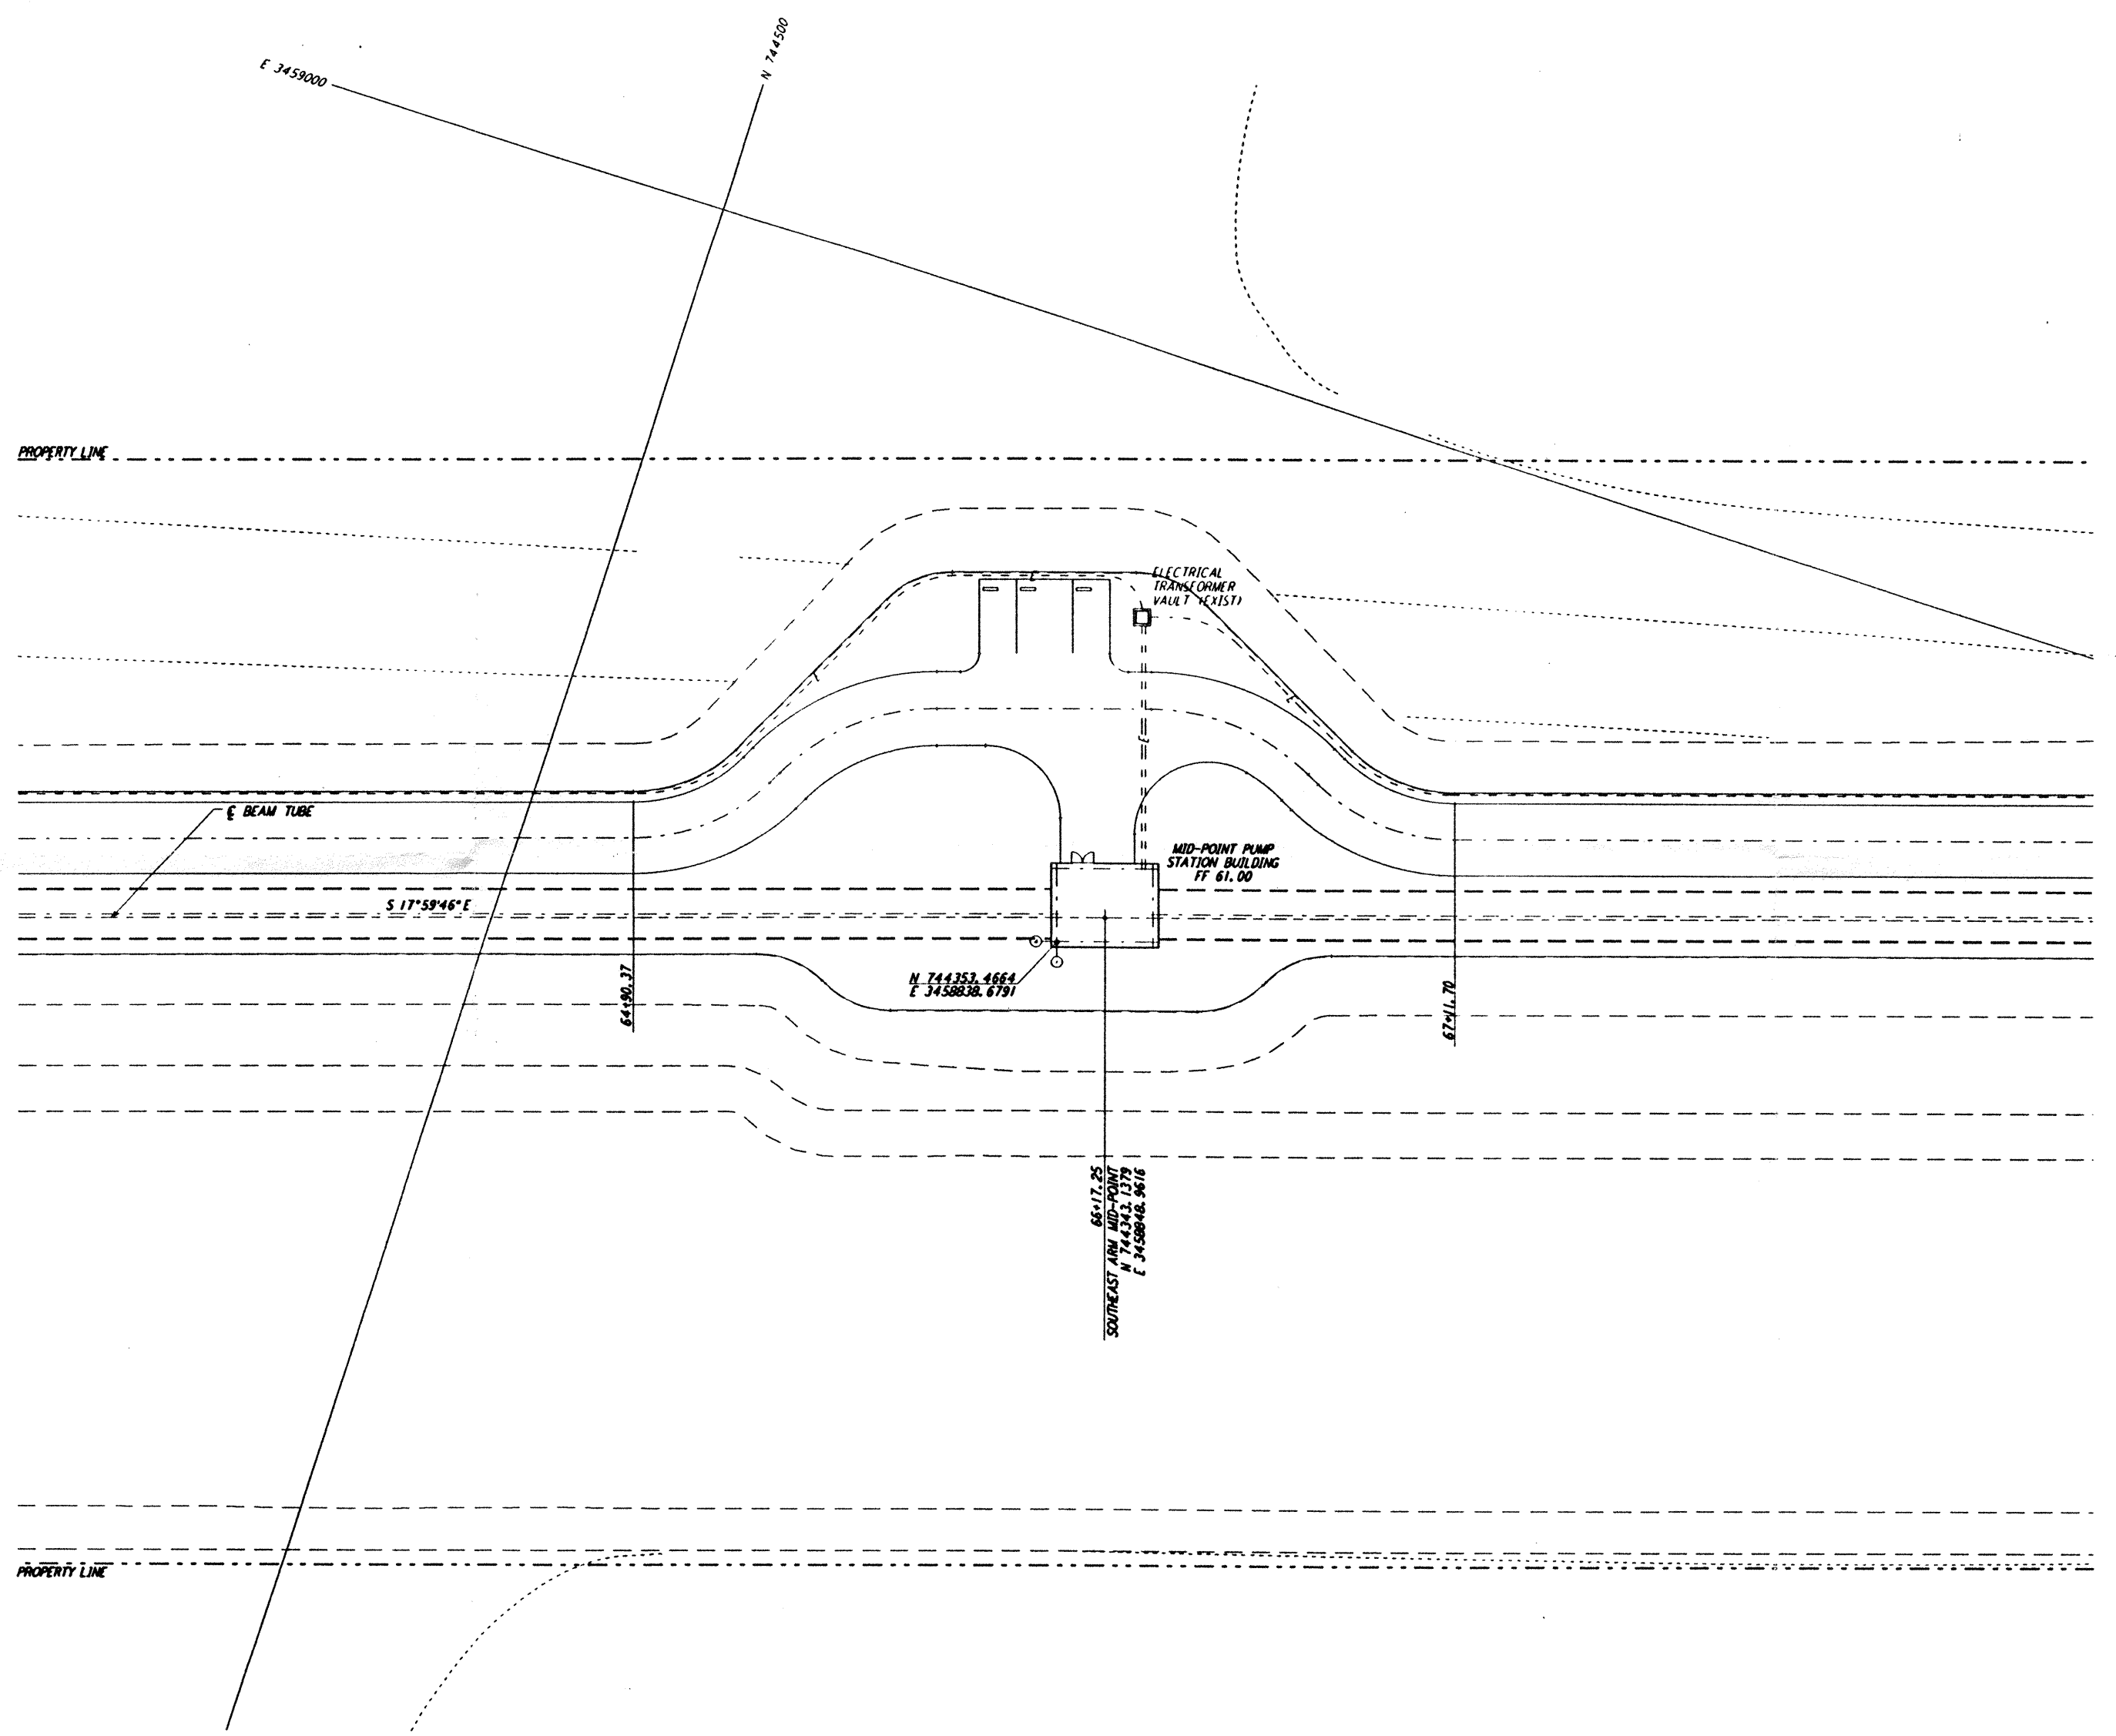


**NOTES:**  
 1. SEE SHEET LA-C-002 FOR GENERAL NOTES, LEGEND AND ABBREVIATIONS.

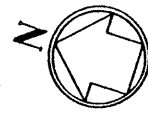

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NO.	DATE	BY	CHKD	ENGR	PROJ	DESCRIPTION
B	7/24/96	WRB	ML	MS	2001	ISSUED FOR BID
A	6/14/96	WRB	ML	TDM		FINAL DESIGN REVIEW

DRAWN	WRB
CHECKED	
ENGINEER	
PROJ	

**PARSONS**  
 100 WEST WALNUT STREET  
 PASADENA, CALIFORNIA

**LIGO**  
 CALIFORNIA INSTITUTE OF TECHNOLOGY  
 MASSACHUSETTS INSTITUTE OF TECHNOLOGY

**LASER INTERFEROMETER  
 GRAVITATIONAL-WAVE OBSERVATORY  
 SITE NO. 2 - LIVINGSTON, LOUISIANA**

TITLE: CIVIL  
 SOUTHEAST ARM  
 PUMP STATION  
 UTILITY PLAN

SCALE: 1" = 20'

PROJECT NUMBER: PP150969  
 SHEET NUMBER: 8094  
**LA-C-043**

Tue Jul 23 07:59:06 1996 s3-v18b2 J:\PLOTS\QUEUES\18B2\CE043B.PRF