




END STATIONS ROOF PLAN  
 1/8" = 1'-0"  
 LA-A-221

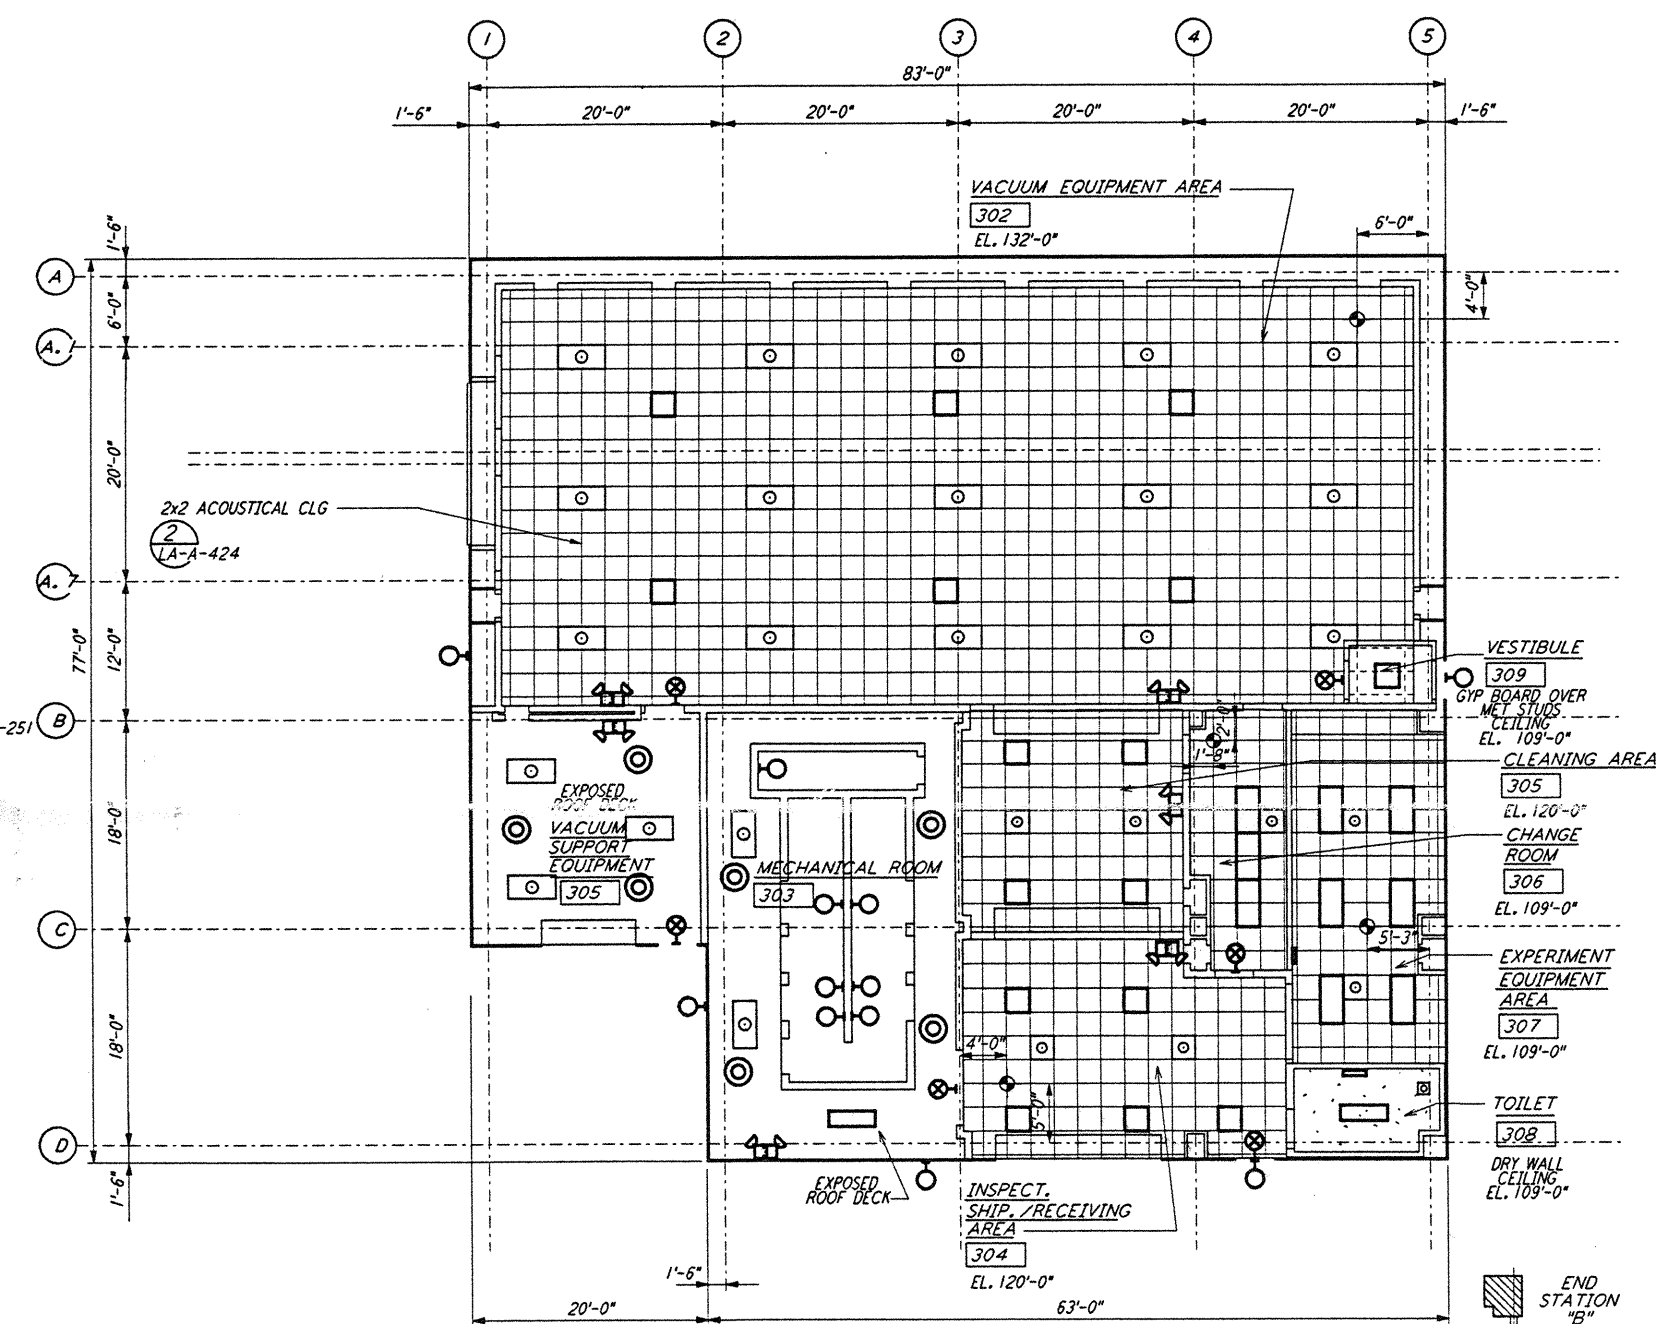

END STATIONS REFLECTED CEILING PLAN  
 1/8" = 1'-0"  
 LA-A-221

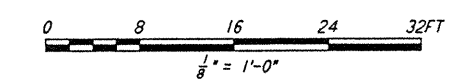

DATUM POINT EL. +100.00 = 57.46' ( END STATION "B")  
 DATUM POINT EL. +100.00 = 61.49' ( END STATION "A")

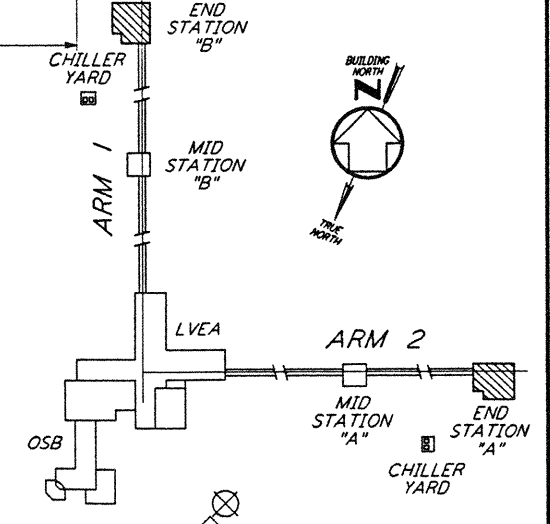

KEY PLAN  
 LIGO-D960894-B-0

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NO.	DATE	BY	CHKD	ENGR	PROJ	DESCRIPTION
B	6-14-96	CKT	BK	SF	TOM	FINAL DESIGN REVIEW
A	10/31/95	SF	SF	TOM		PRELIMINARY DESIGN REVIEW

DRAWN	CKT
CHECKED	
ENGINEER	
PROJ	

**PARSONS**  
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 PASADENA, CALIFORNIA

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 MASSACHUSETTS INSTITUTE OF TECHNOLOGY

LASER INTERFEROMETER  
 GRAVITATIONAL-WAVE OBSERVATORY  
 SITE NO. 2 - LIVINGSTON, LOUISIANA

TITLE: ARCHITECTURAL END STATIONS REFLECTED CEILING PLAN & ROOF PLAN  
 SCALE: AS NOTED  
 CONTRACT NUMBER: PP150969  
 PROJECT NUMBER: 8094

SHEET NUMBER: **LA-A-221**