
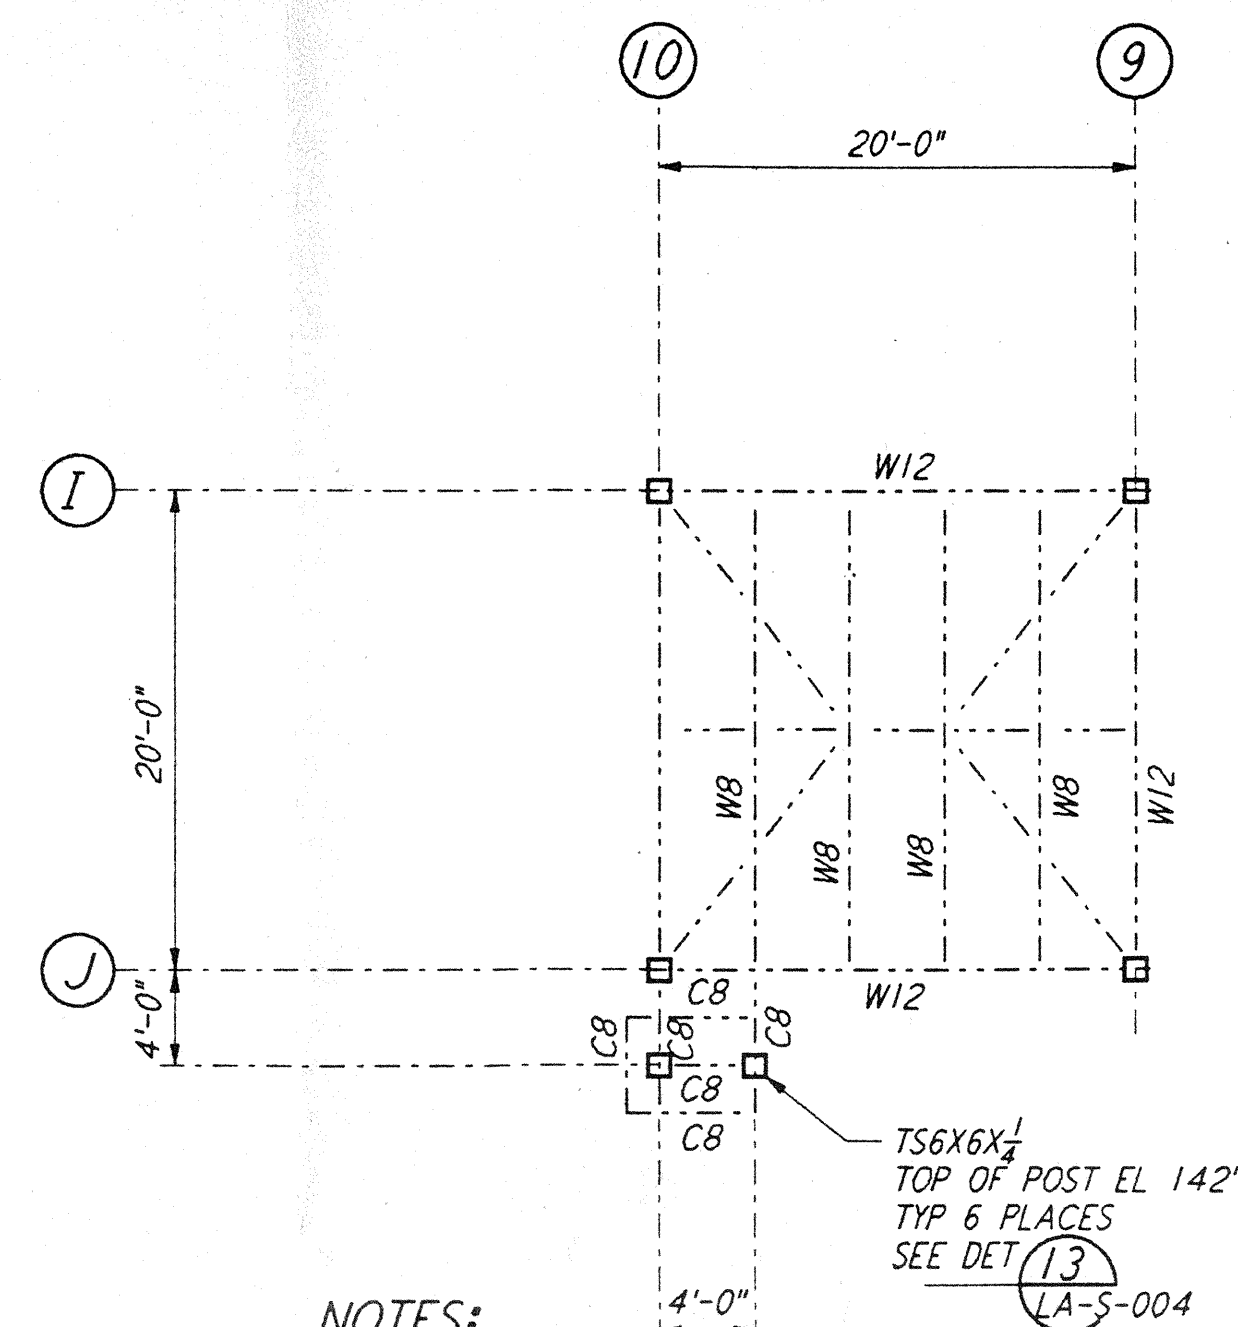




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NOTES:
 1. PLATFORM SHALL BE DESIGN AND SUPPLIED BY CONTRACTOR. FOR INFORMATION NOT SHOWN SEE ARCHITECTURAL DWGS.
 2. FOR SUPPORT POSTS, SEE STRUCTURAL FRAMING ELEVATIONS.


ROOF PLATFORM SUPPORT PLAN
 $\frac{1}{8}'' = 1'-0''$

NOTES:
 1. FOR GENERAL NOTES SEE DRAWING LA-S-001.
 2. NUMBER IN PARENTHESIS FOLLOWING MEMBER SIZE FOR ROOF BEAMS WITH 40 FEET OR 60 FEET SPAN INDICATES REQUIRED CAMBER IN INCHES.
 3. FOR BEAM TO BEAM CONNECTIONS, SEE DETAIL (3) TYP UON LA-S-005
 4. FOR BEAM TO COLUMN CONNECTIONS, SEE DETAILS (6) & (4) TYP UON LA-S-004 & LA-S-007
 5. FOR HORIZONTAL BRACING CONNECTIONS, SEE DETAILS (11) LA-S-006, (12) LA-S-006 & (13) LA-S-006

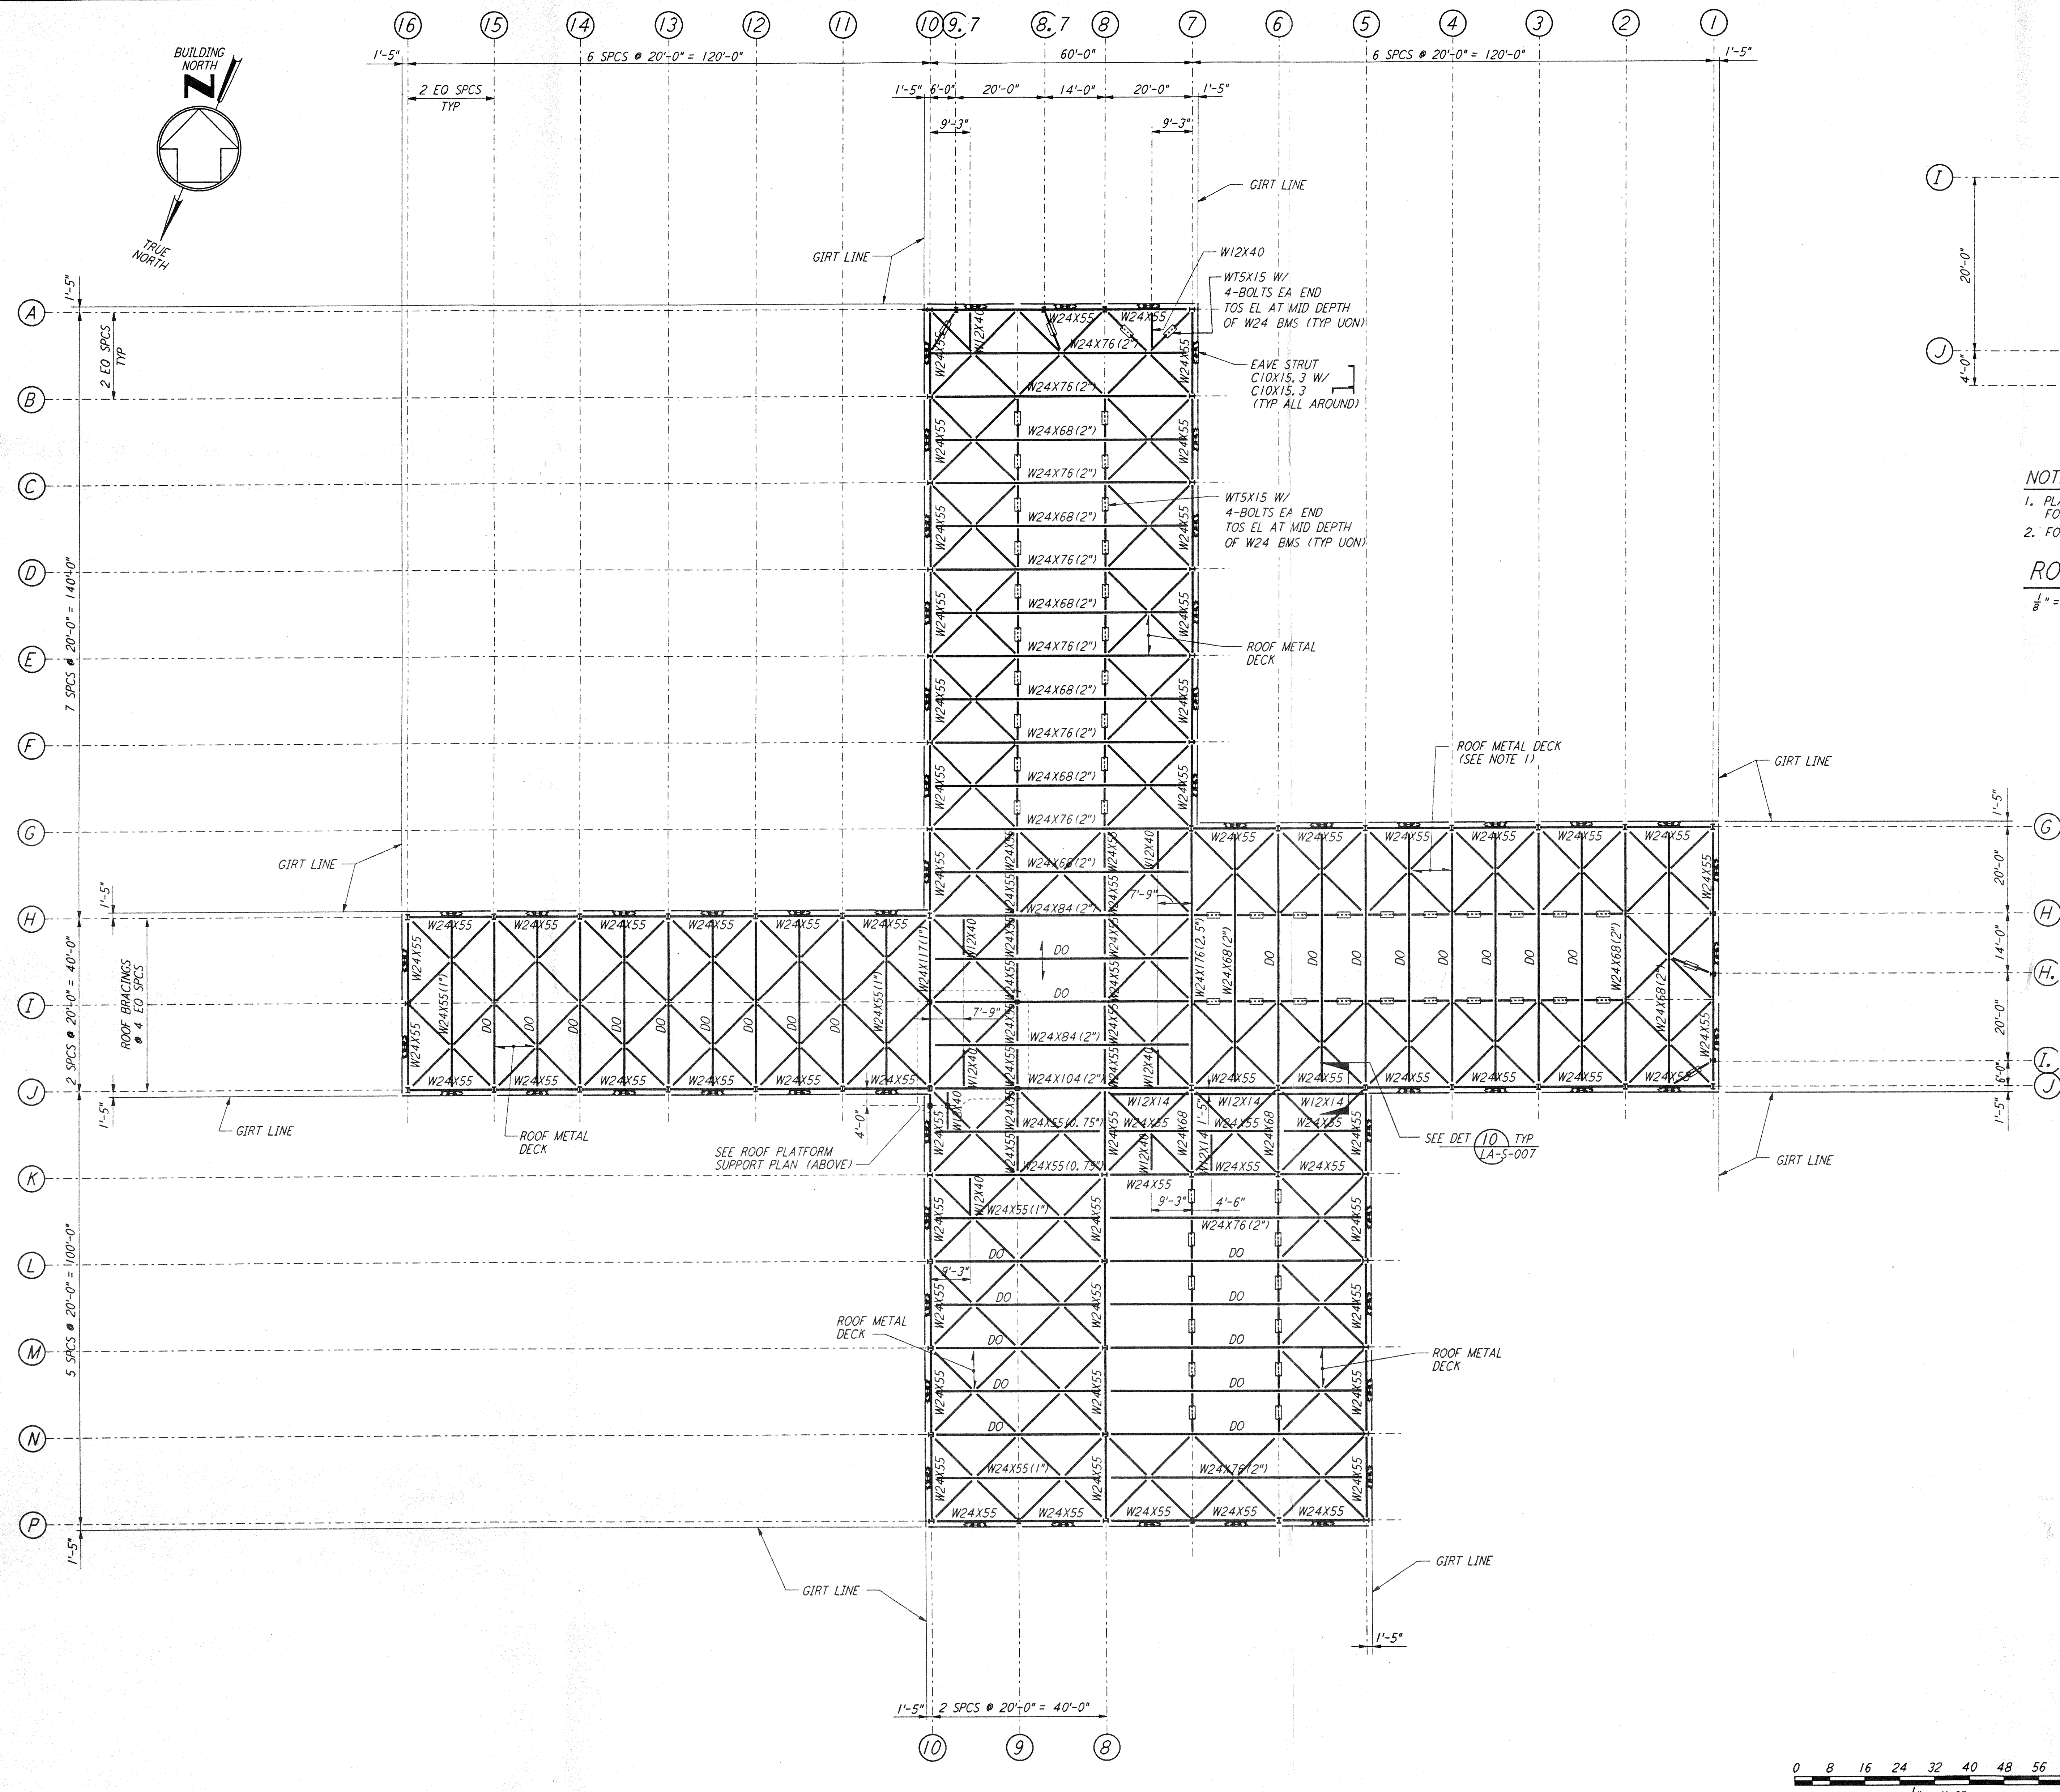

DRAWING NO.	DESCRIPTION	NO.	DATE	BY	CHKD	ENGR	PROJ	DESCRIPTION

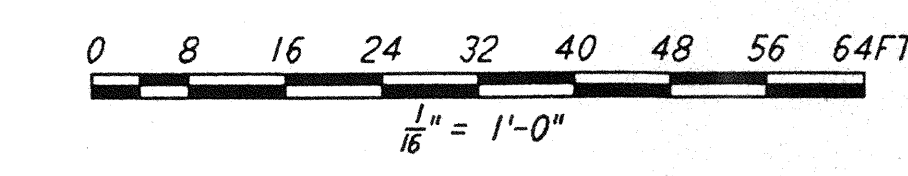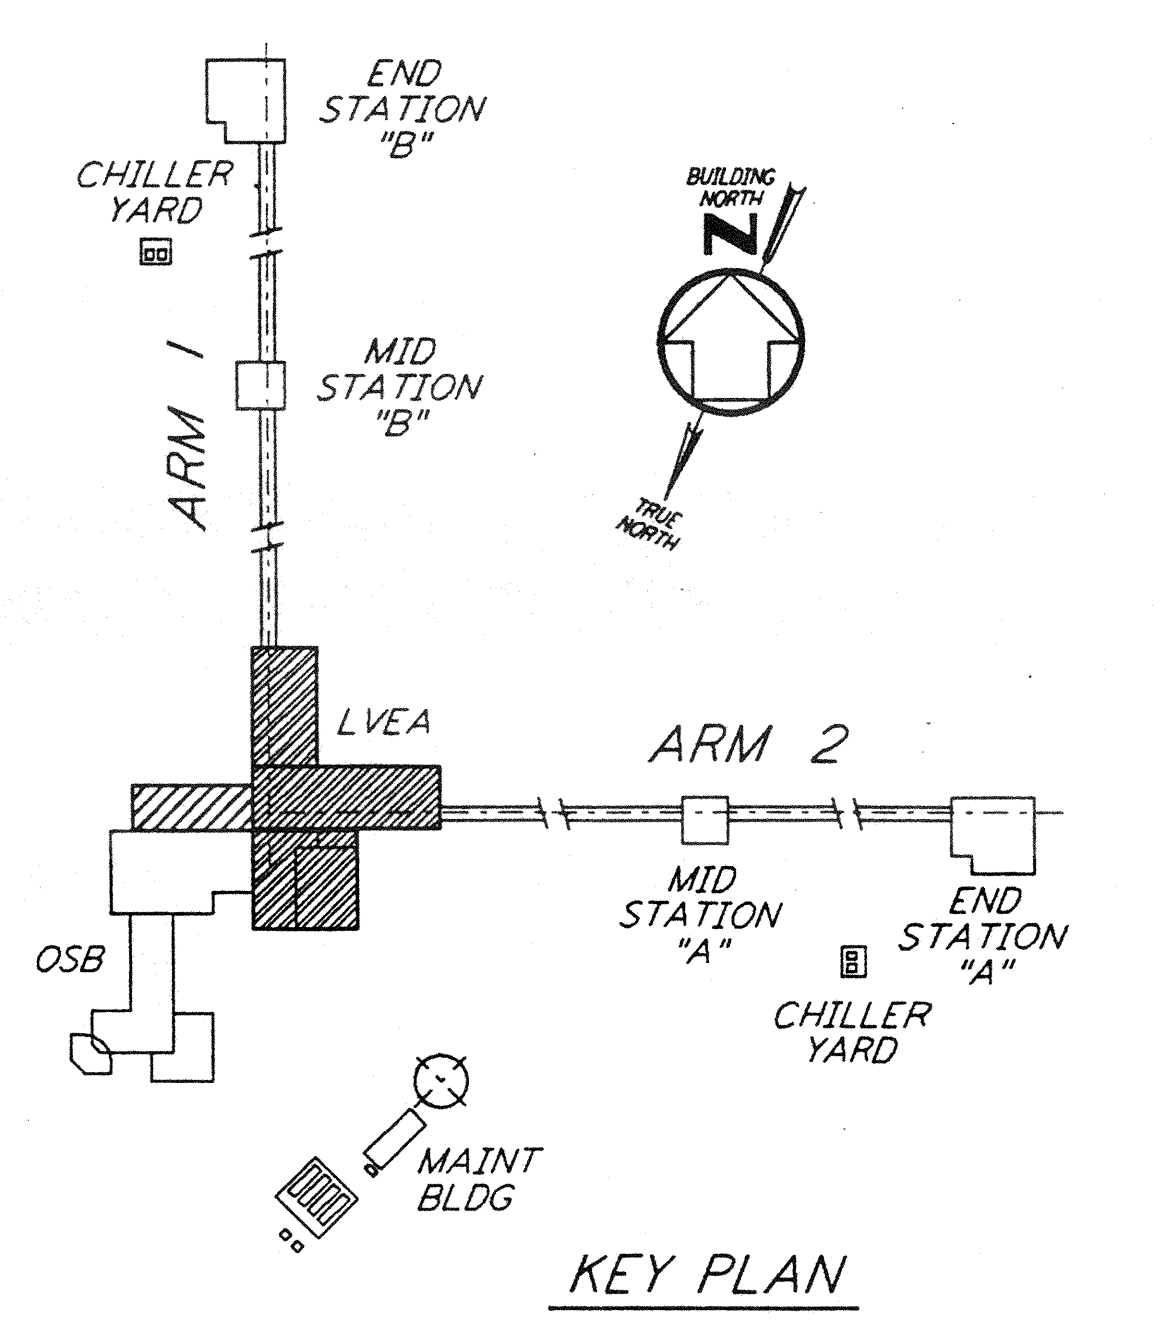ISSUED FOR CONSTRUCTION	DATE	BY
DRAWN	MCS	11-15-96
CHECKED		11-15-96
ENGINEER		11-15-96
PROJ		11-15-96

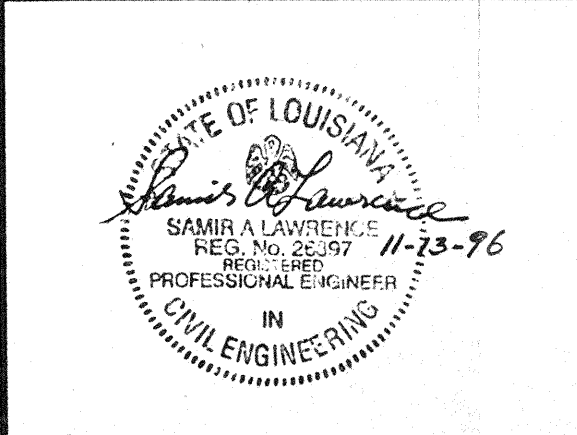

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LASER INTERFEROMETER
 GRAVITATIONAL-WAVE OBSERVATORY
 SITE NO. 2 - LIVINGSTON, LOUISIANA

STRUCTURAL CORNER STATION LVEA ROOF FRAMING PLAN

SCALE: AS NOTED CONTRACT NUMBER: PPI50969 PROJECT NUMBER: 8094
 SHEET NUMBER: **LA-S-105**