




**HIGH ROOF FRAMING PLAN**  
 $\frac{1}{8}'' = 1'-0''$

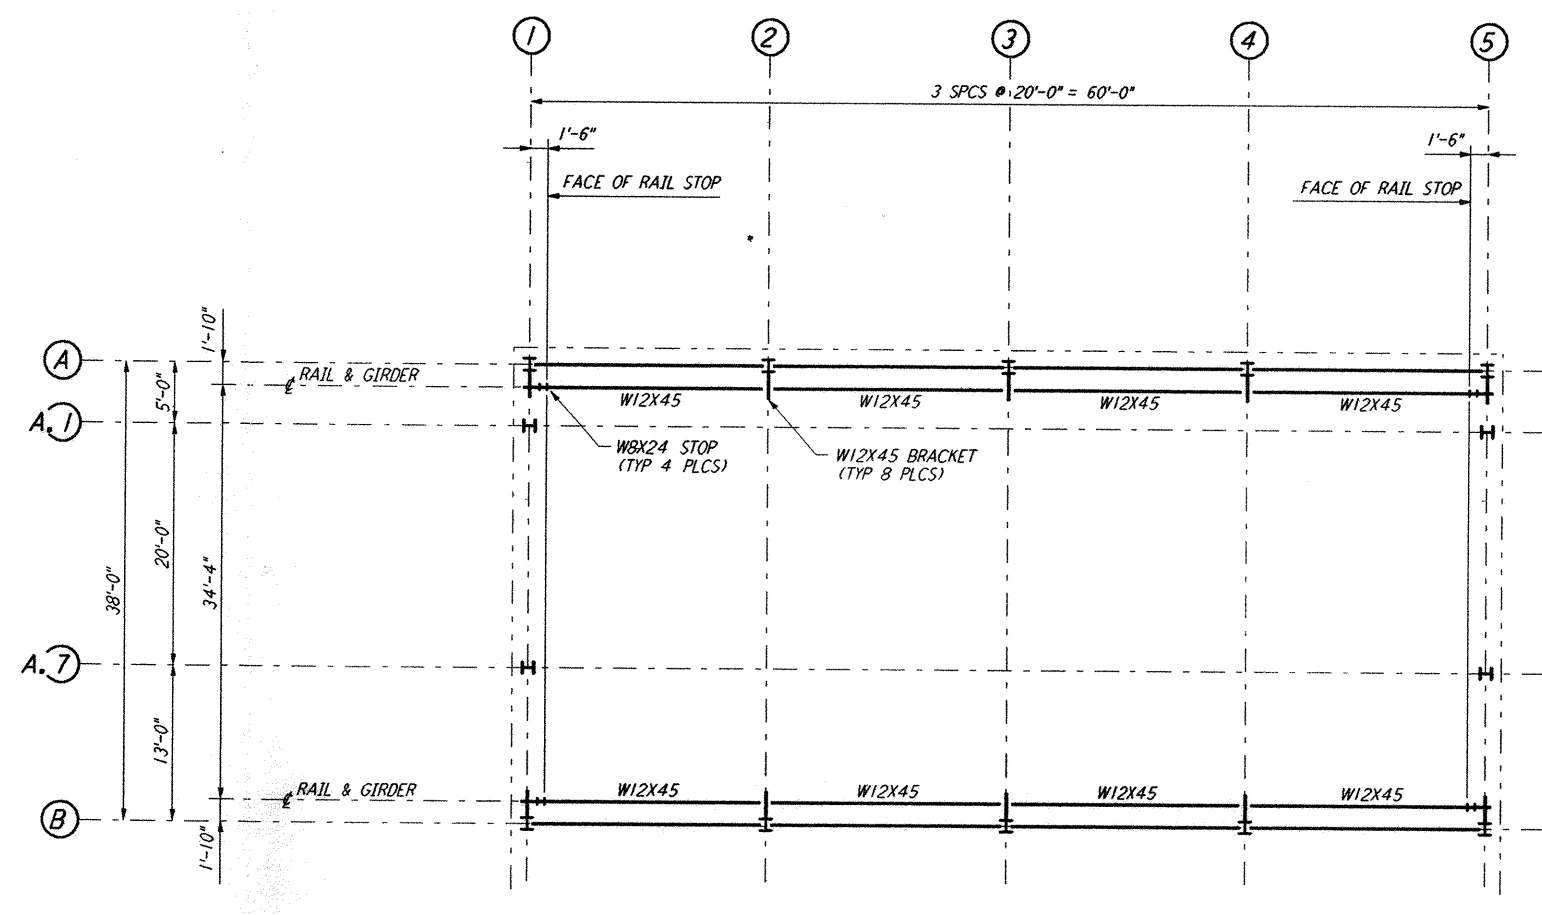

**CRANE GIRDER FRAMING PLAN**  
 $\frac{1}{8}'' = 1'-0''$

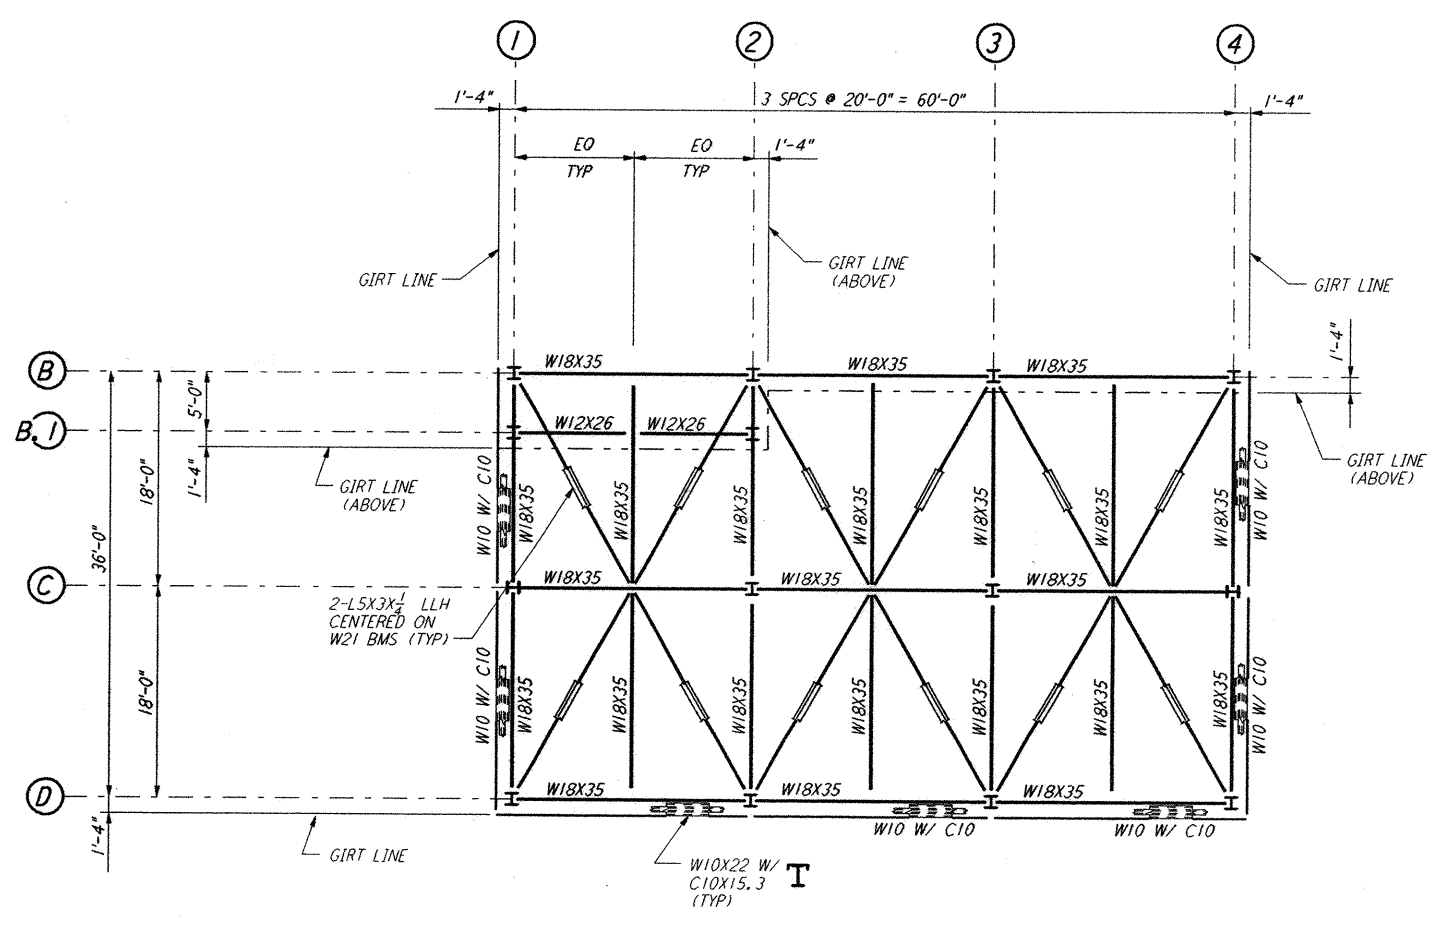

**LOW ROOF FRAMING PLAN**  
 $\frac{1}{8}'' = 1'-0''$

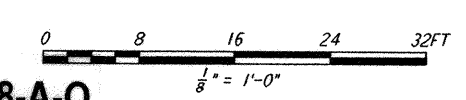

LIGO-D960948-A-O

NO.	DATE	APPROVED BY	DESCRIPTION OF REVISION

NO.	DATE	APPROVED BY	ISSUED FOR

DATE	10-31-95
DRAWN	MCS
CHECKED	
ENGINEER	
PROJ MGR	

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LASER INTERFEROMETER  
 GRAVITATIONAL-WAVE OBSERVATORY  
 SITE NO. 2 - LIVINGSTON, LOUISIANA

TITLE: **END STATION ROOF & CRANE GIRDER FRAMING PLANS**

SCALE: AS NOTED

CONTRACT NUMBER: PP150969

PROJECT NUMBER: 8094

SHEET NUMBER: **LA-S-304**

REVISIONS:

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Mon Oct 30 19:56:59 1995 s3-v18b2 J:\PLOTS\QUEUES\18B2\ST304.PRF