

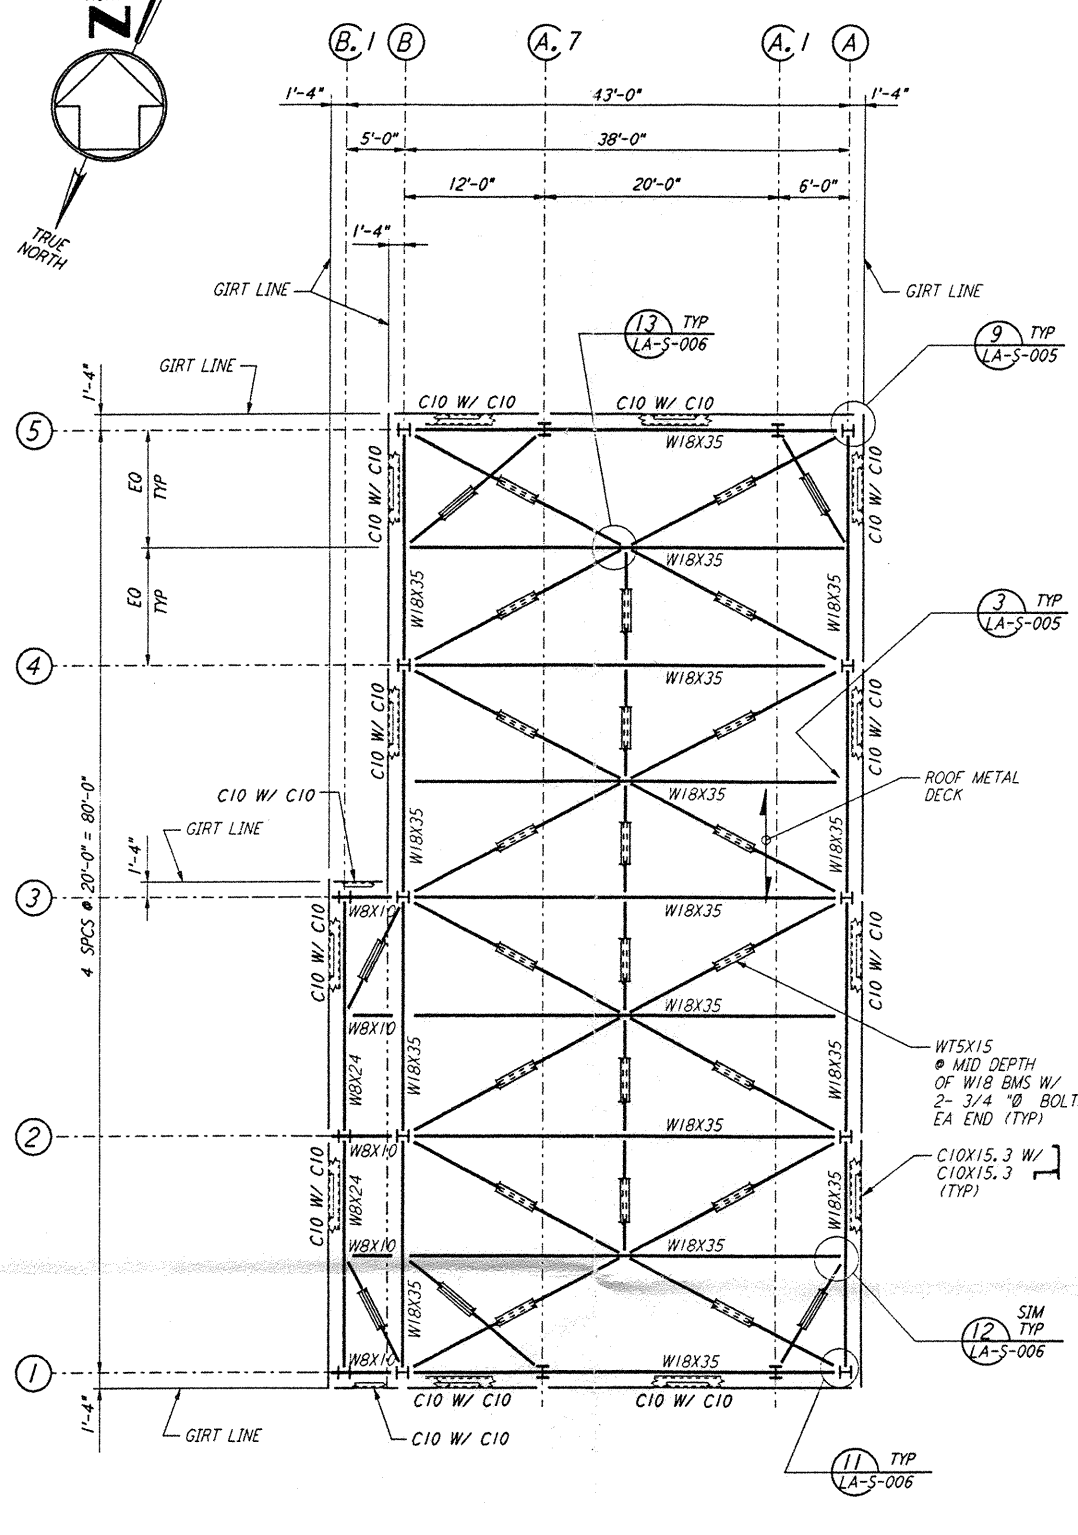
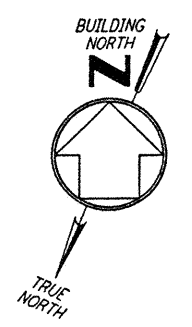


FOR END STATION "B" ON ARM 1
 LOW ROOF FRAMING PLAN
 1/8" = 1'-0"


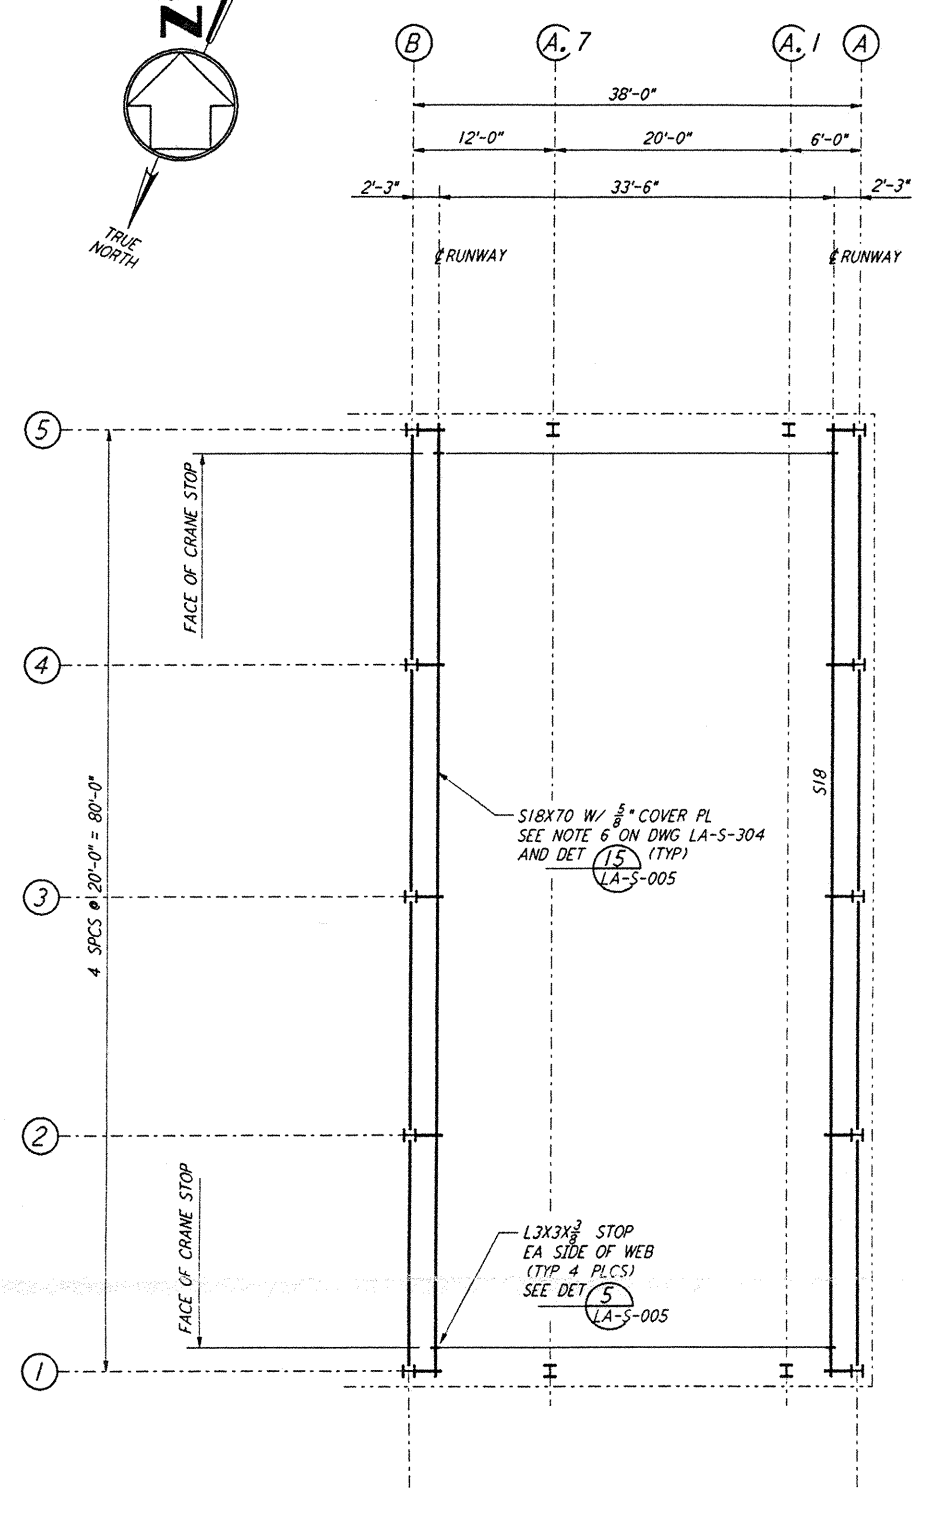


FOR END STATION "B" ON ARM 1
 HIGH ROOF FRAMING PLAN
 1/8" = 1'-0"

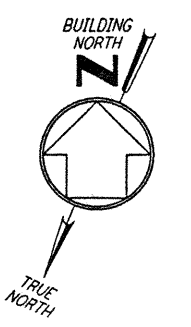

FOR END STATION "B" ON ARM 1
 CRANE GIRDER FRAMING PLAN
 1/8" = 1'-0"

NOTE:
 1. FOR NOTES SEE DRAWING LA-S-304.

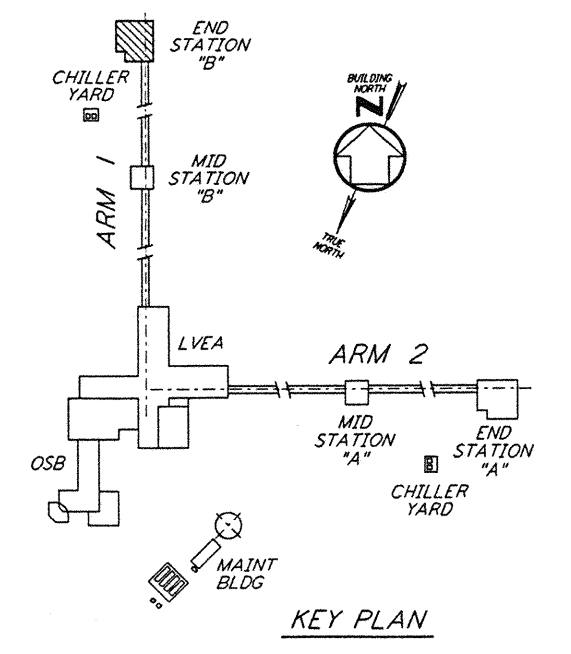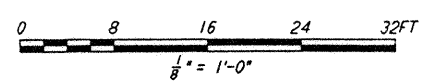


KEY PLAN

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NO.	DATE	BY	CHKD	ENGR	PROJ	DESCRIPTION

ISSUED FOR CONSTRUCTION	
DRAWN	MCS 11-15-96
CHECKED	11-15-96
ENGINEER	11-15-96
PROJ	11/15/96

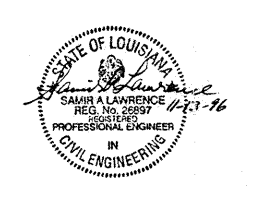

PARSONS
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 PASADENA, CALIFORNIA

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 CALIFORNIA INSTITUTE OF TECHNOLOGY
 MASSACHUSETTS INSTITUTE OF TECHNOLOGY

LASER INTERFEROMETER
 GRAVITATIONAL-WAVE OBSERVATORY
 SITE NO. 2 - LIVINGSTON, LOUISIANA

TITLE: STRUCTURAL END STATION "B" ROOF & CRANE GIRDER FRAMING PLANS
 SCALE: AS NOTED
 CONTRACT NUMBER: PPI 50969
 SHEET NUMBER: 8094
LA-S-308

LIGO-D960952-00-D

LIGOLAF.BDR