



NOTES:

1. FOR LEGEND, ABBREVIATIONS AND GENERAL NOTES SEE SHEETS LA-H-001 AND LA-H-002.
2. SEE FLOOR PLAN NOTES FOR DUCT INSULATION.

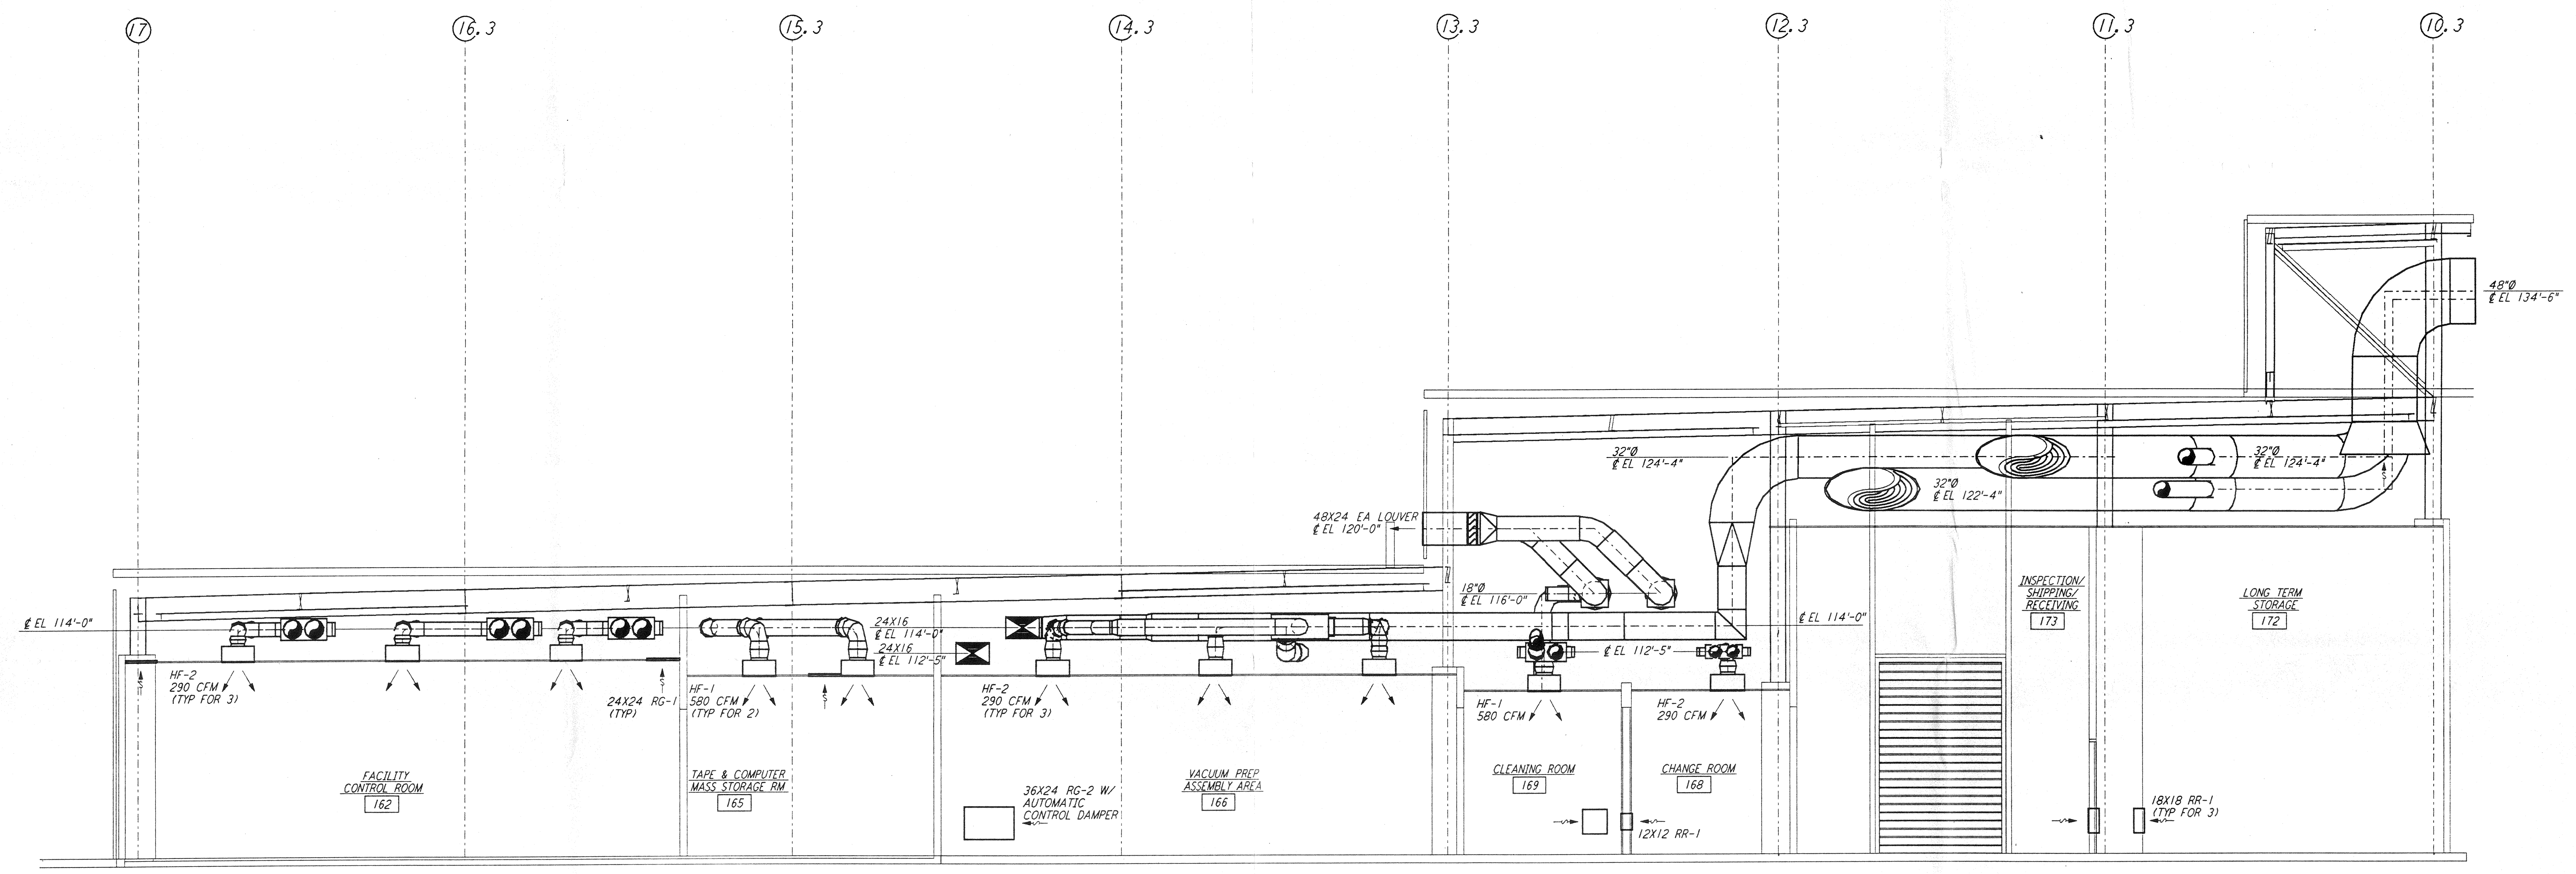

SECTION **D**
 1/2" = 1'-0" REF
 LA-H-153 LA-H-113

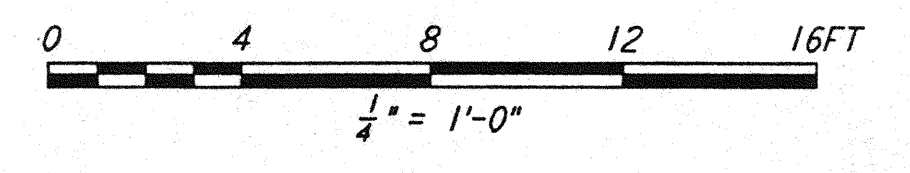


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NO.	DATE	BY	CHKD	ENGR	PROJ	DESCRIPTION

ISSUED FOR CONSTRUCTION		
DRAWN	CLP	11-15-96
CHECKED	MPZ	10-25-96
ENGINEER	AA	10-23-96
PROJ		11/15/96



PARSONS
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 PASADENA, CALIFORNIA
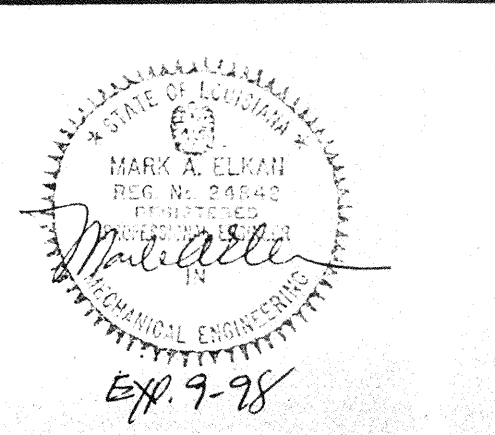
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LASER INTERFEROMETER
 GRAVITATIONAL-WAVE OBSERVATORY
 SITE NO. 2 - LIVINGSTON, LOUISIANA

HVAC
 CORNER STATION
 SECTIONS SHEET 3

SCALE: AS NOTED
 CONTRACT NUMBER: PP150969
 PROJECT NUMBER: 8094

SHEET NUMBER: **LA-H-153**