



NOTES:
 1. FOR LEGEND, ABBREVIATIONS AND GENERAL NOTES SEE SHEETS
 LA-H-001 AND LA-H-002.

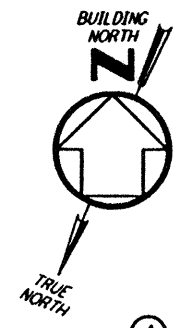


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END STATION "A" PIPING PLAN
 1/4" = 1'-0"

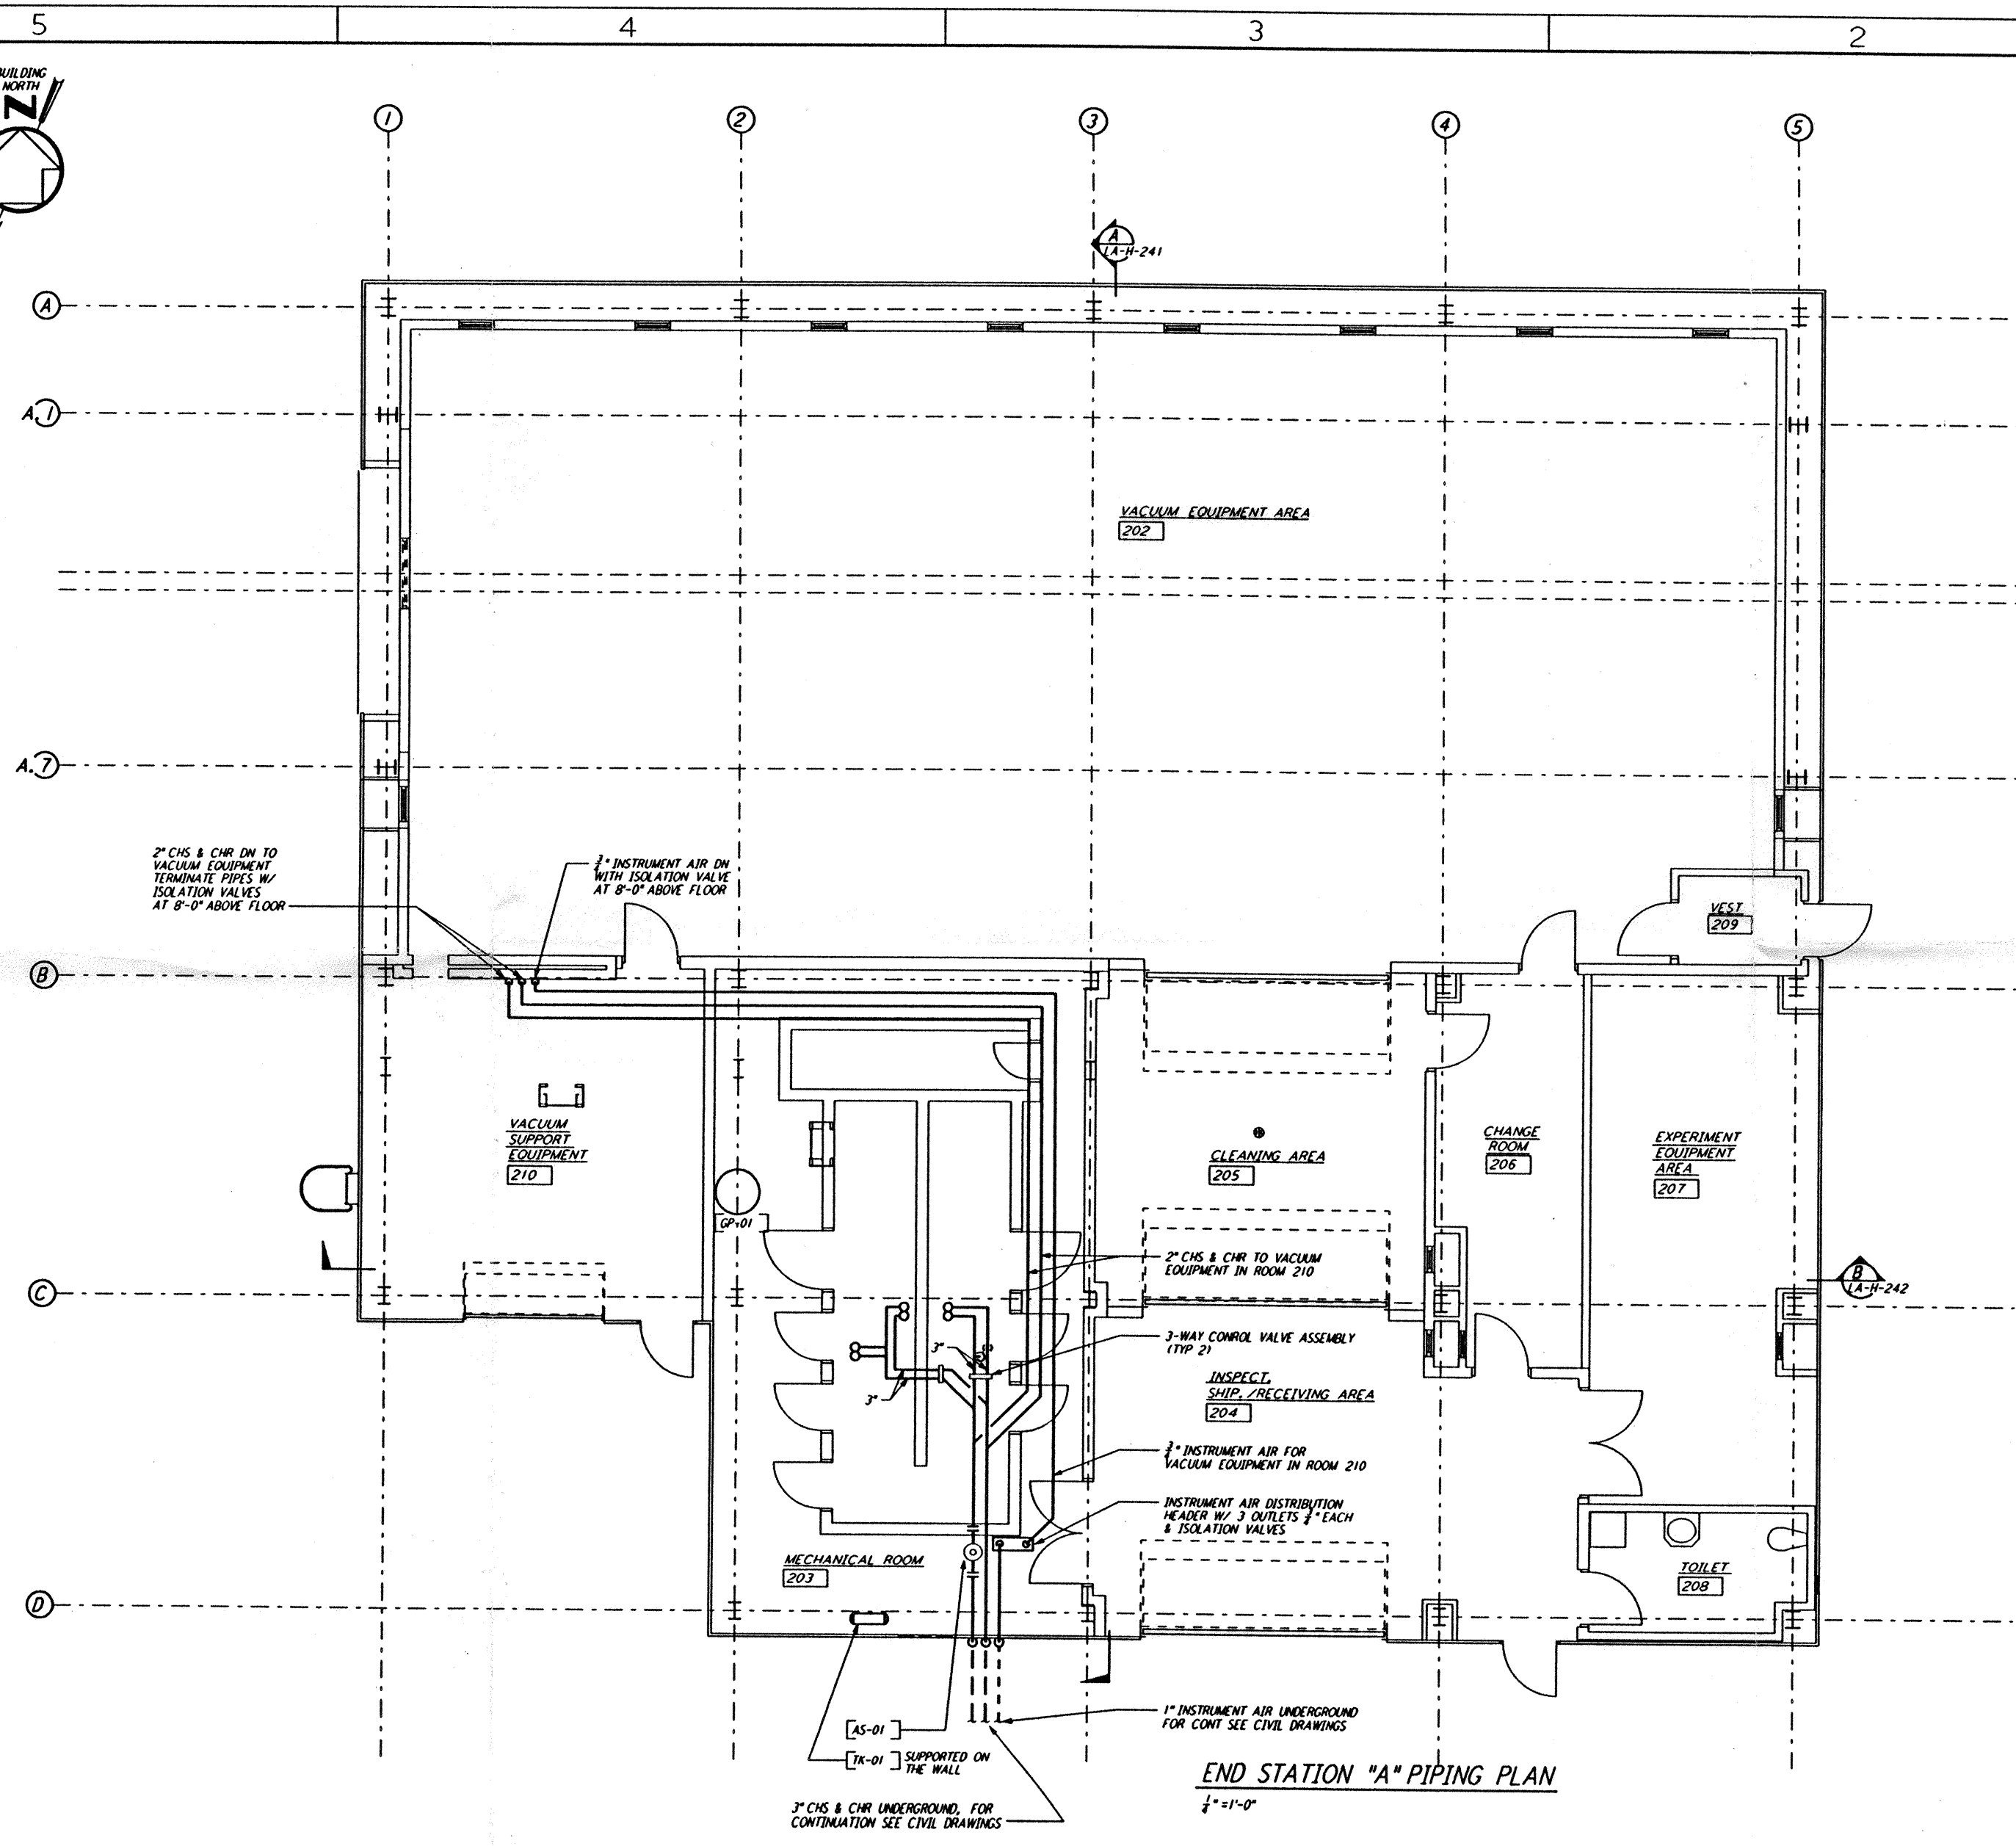

KEY PLAN

NO.	DATE	BY	CHKD	ENGR	PROJ	DESCRIPTION
B	7-24-96	CLP	AA	TJM		ISSUED FOR BID
A	6-14-96	CLP	AA	TJM		FINAL DESIGN REVIEW

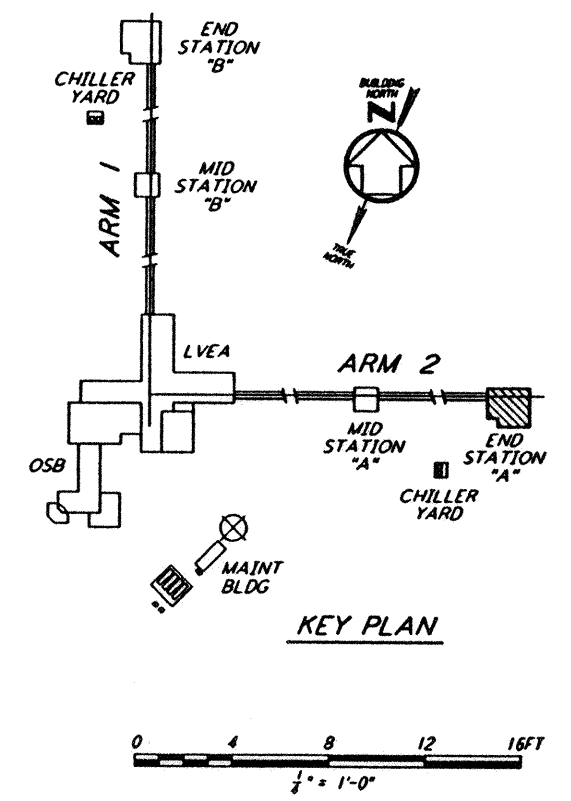DRAWN	CLP
CHECKED	
ENGINEER	
PROJ	

PARSONS
 100 WEST WALNUT STREET
 PASADENA, CALIFORNIA

LIGO
 CALIFORNIA INSTITUTE OF TECHNOLOGY
 MASSACHUSETTS INSTITUTE OF TECHNOLOGY

LASER INTERFEROMETER
 GRAVITATIONAL-WAVE OBSERVATORY
 SITE NO. 2 - LIVINGSTON, LOUISIANA

SCALE: AS NOTED
 CONTRACT NUMBER: PP150969
 PROJECT NUMBER: 8094

TITLE: HVAC
 END STATION "A"
 PIPING PLAN

SHEET NUMBER: **LA-H-215**

LIGO-D960986-B-0

LIGOLAF 3.BOR

Mon Jul 22 15:07:20 1996 s3-v18b2 J:\PLOTS\QUEUES\18B2\MU215B.PRF