





- NOTES:**
1. SEE SHEET LA-C-502 FOR GENERAL NOTES, LEGEND AND ABBREVIATIONS.
 2. SEE SHEET LA-C-504 FOR TYPICAL SECTIONS AND DETAILS.

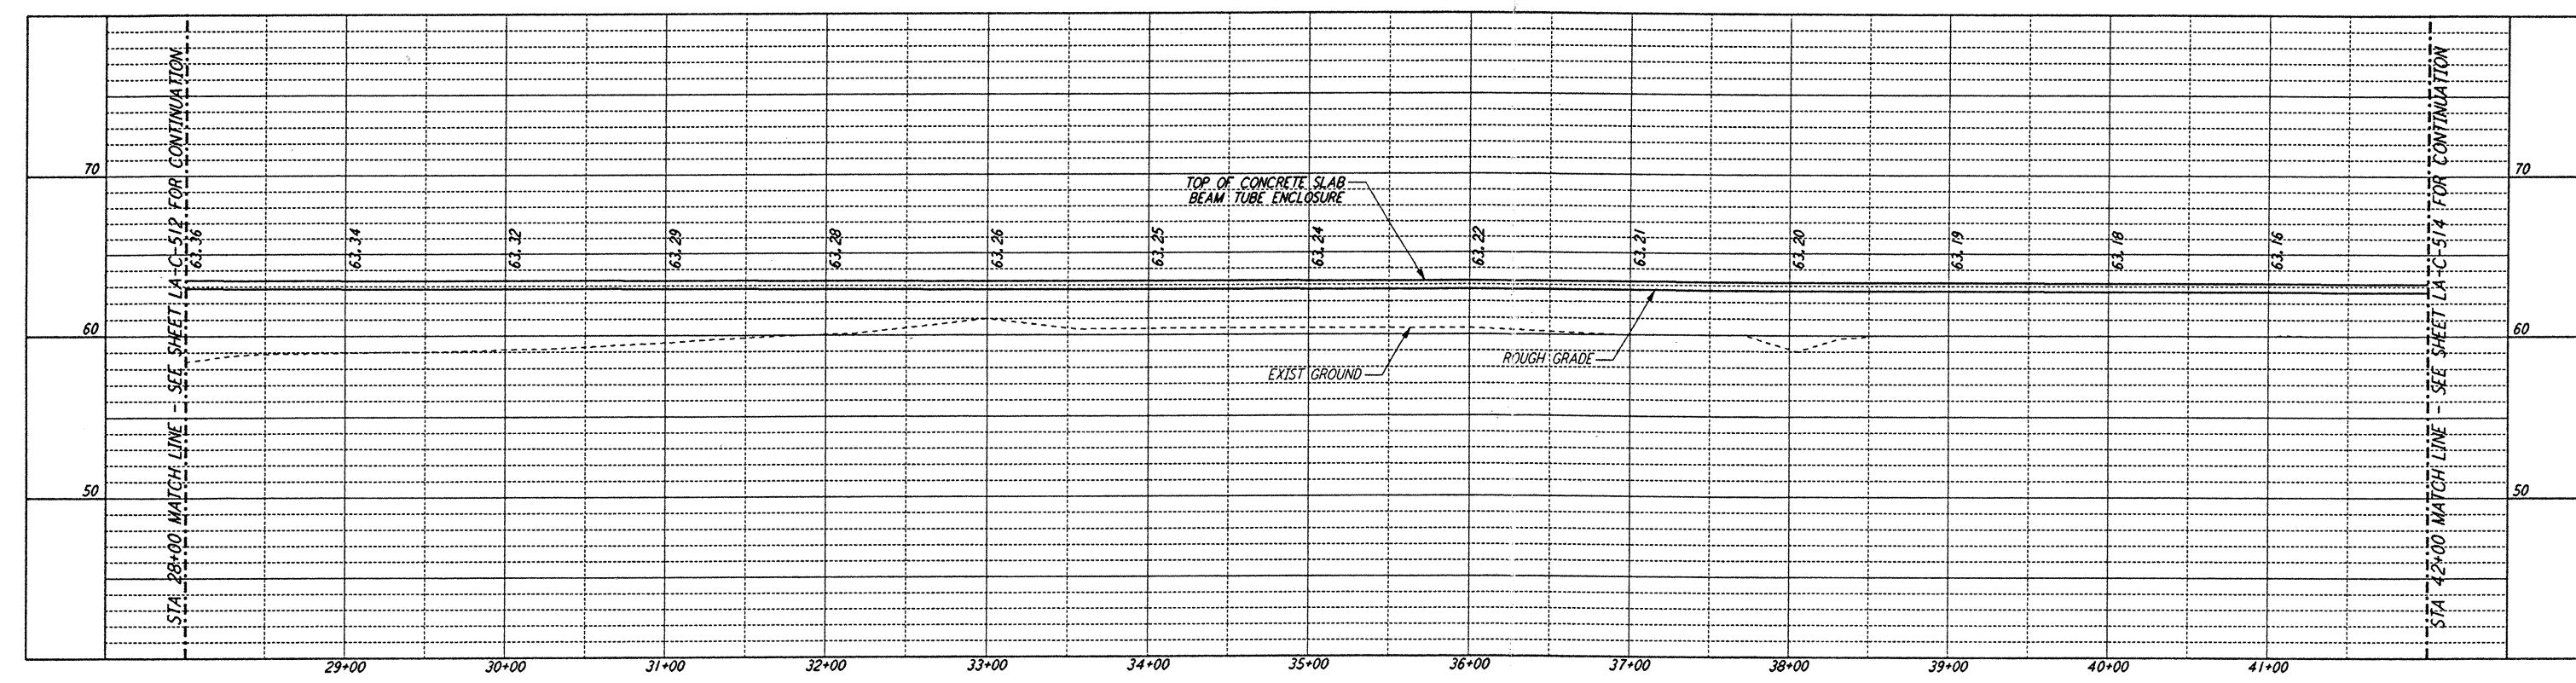

PROFILE
 SCALES: HORIZ: 1" = 50'
 VERT: 1" = 5'

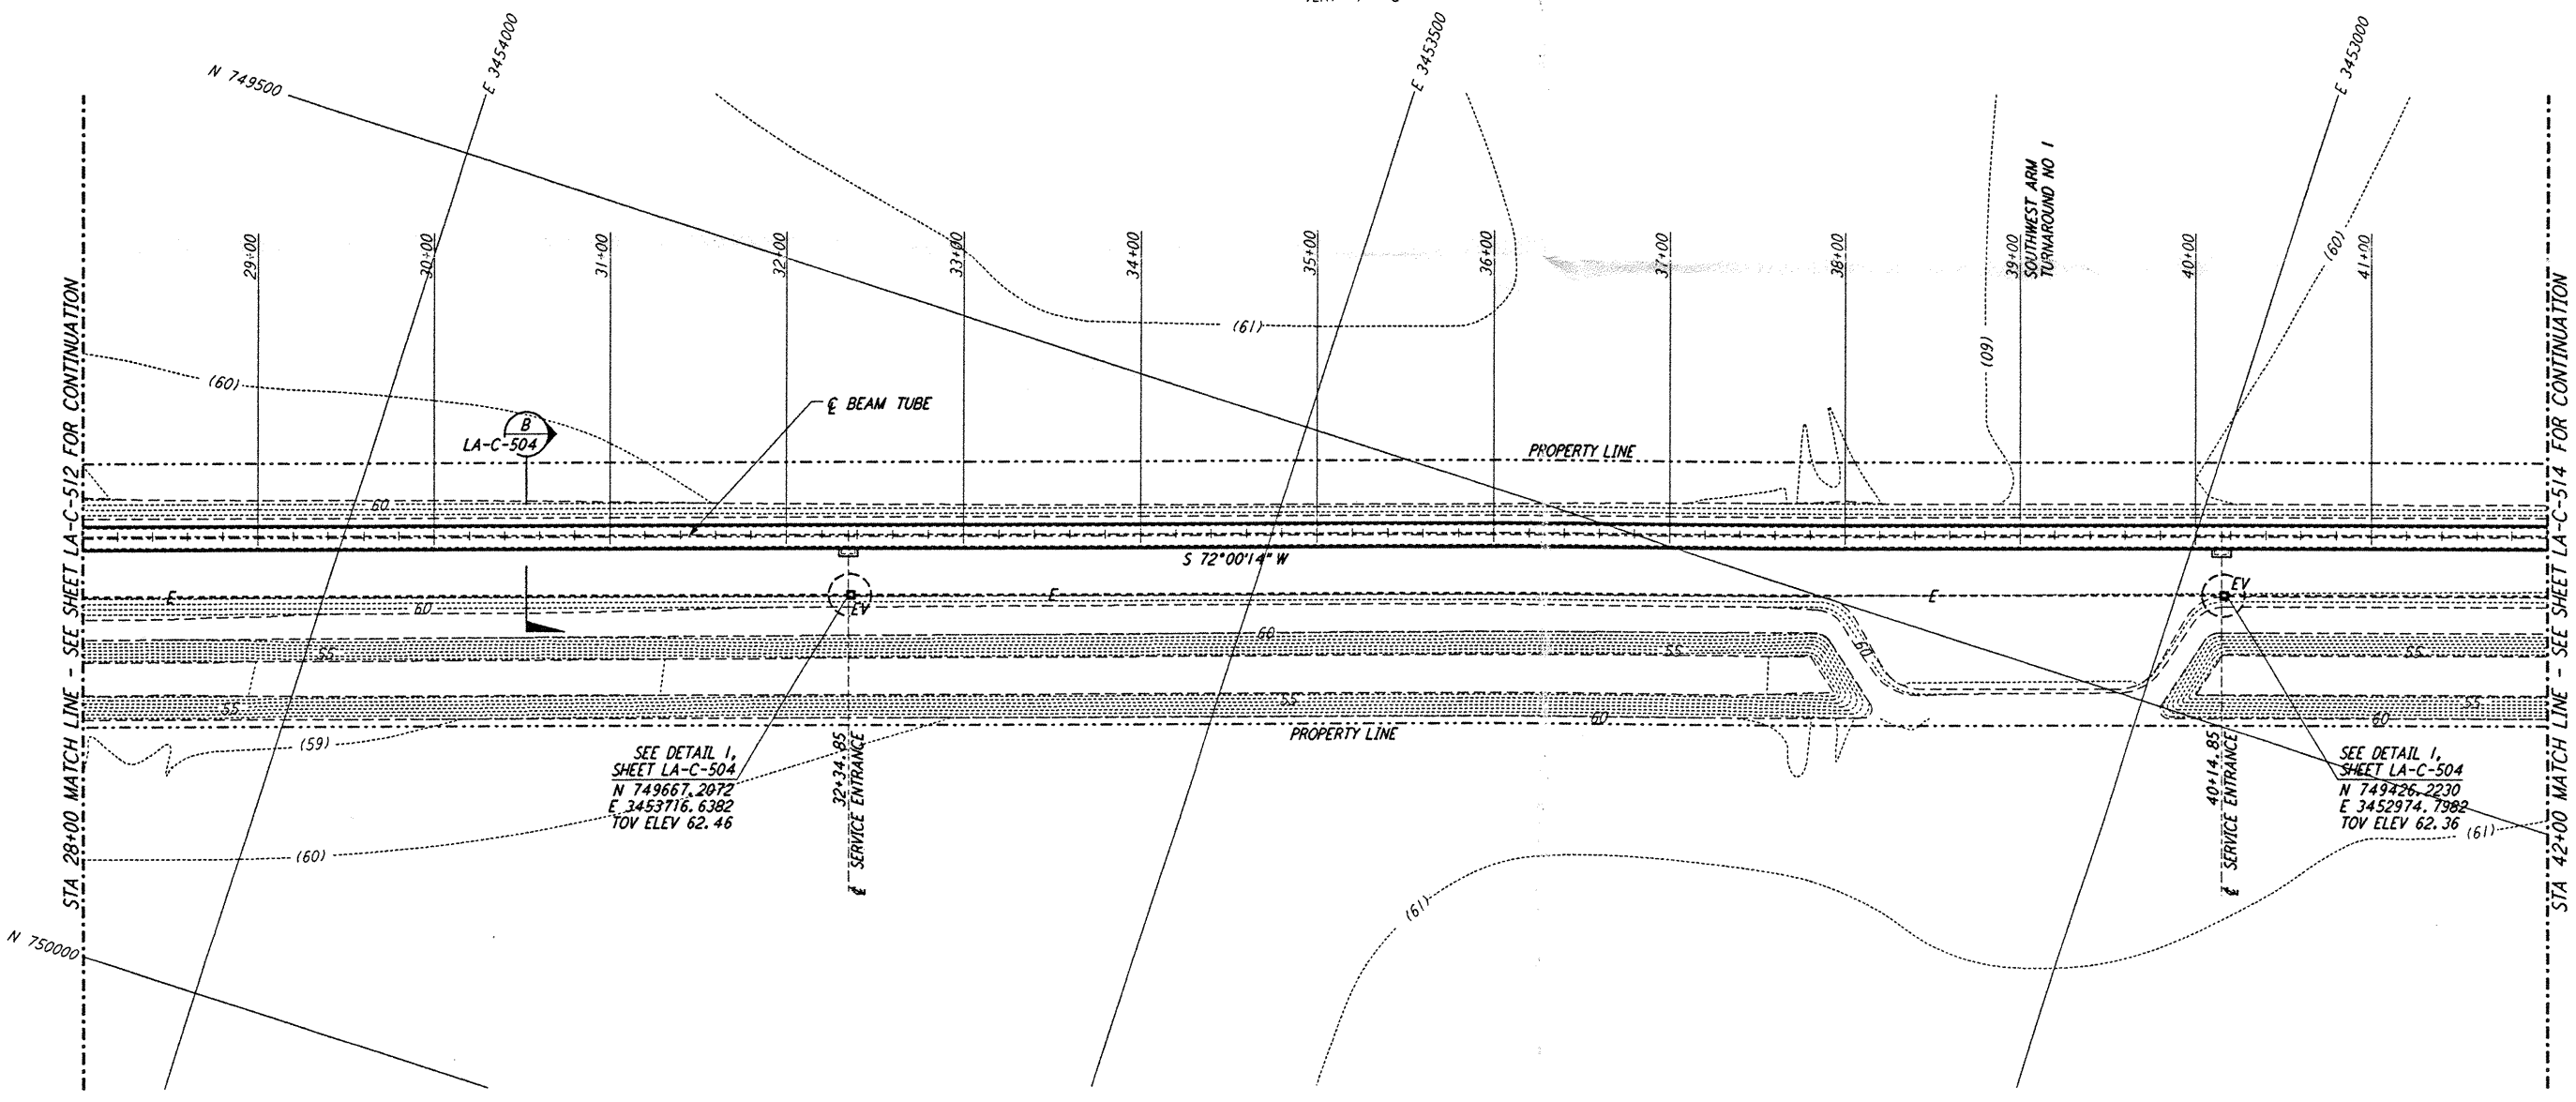

PLAN
 SCALE: 1" = 50'

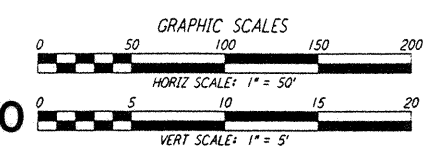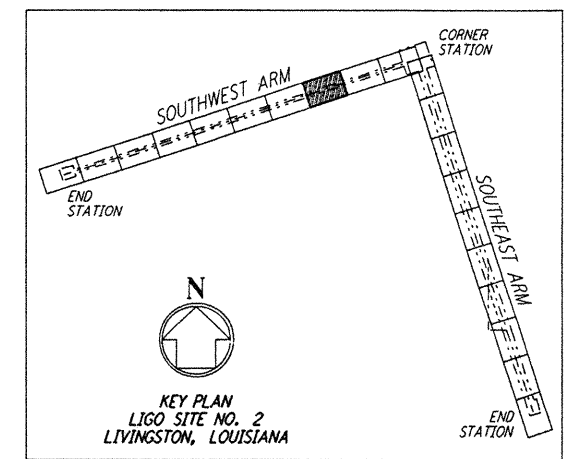

LIGO-D961265-A-O

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NO.	DATE	BY	CHKD	ENGR	PROJ	DESCRIPTION
A	6/28/96	WRB	ML	MDM		FINAL DESIGN REVIEW

DRAWN	WRB	6/24/96
CHECKED		
ENGINEER		
PROJ		

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 PASADENA, CALIFORNIA

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 MASSACHUSETTS INSTITUTE OF TECHNOLOGY

LASER INTERFEROMETER
 GRAVITATIONAL-WAVE OBSERVATORY
 BTE SITWORK & FABRICATION - LIVINGSTON, LA

TITLE: CIVIL
 SHEET NUMBER: AS NOTED
 CONTRACT NUMBER: PPI50969
 PROJECT NUMBER: 8094

SOUTHWEST ARM
 PLAN AND PROFILE
 STA 28+00 TO STA 42+00

LA-C-513

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