
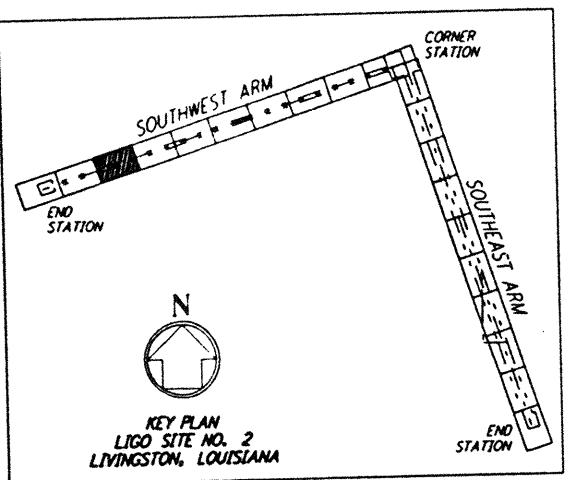
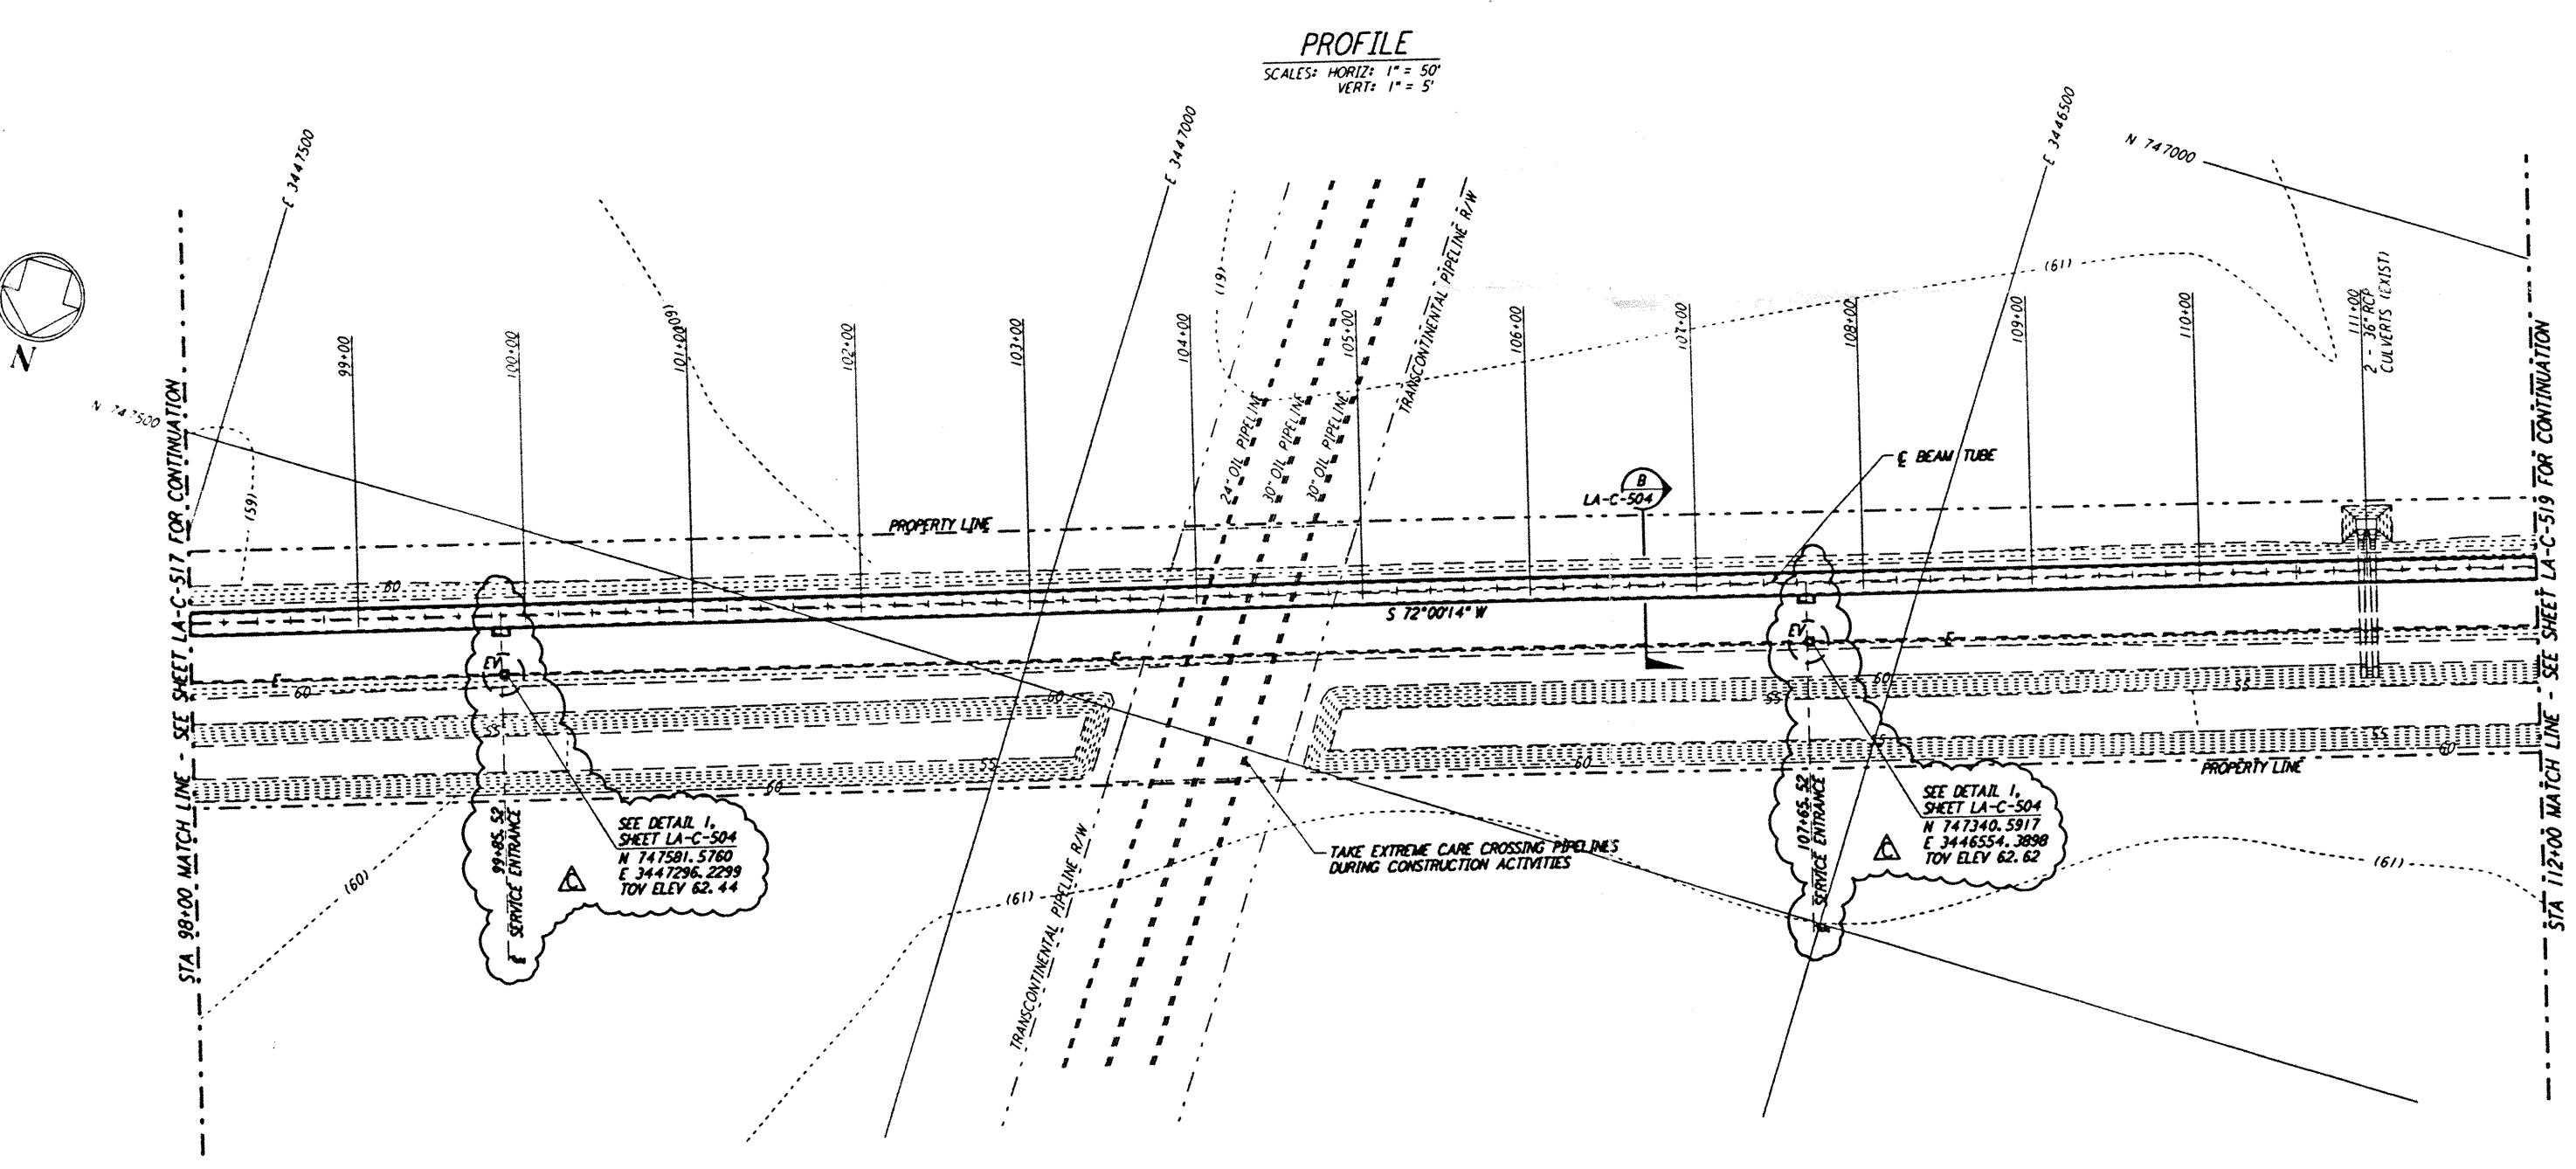


NOTES:
1. SEE SHEET LA-C-502 FOR GENERAL NOTES, LEGEND AND ABBREVIATIONS.
2. SEE SHEET LA-C-504 FOR TYPICAL SECTIONS AND DETAILS.

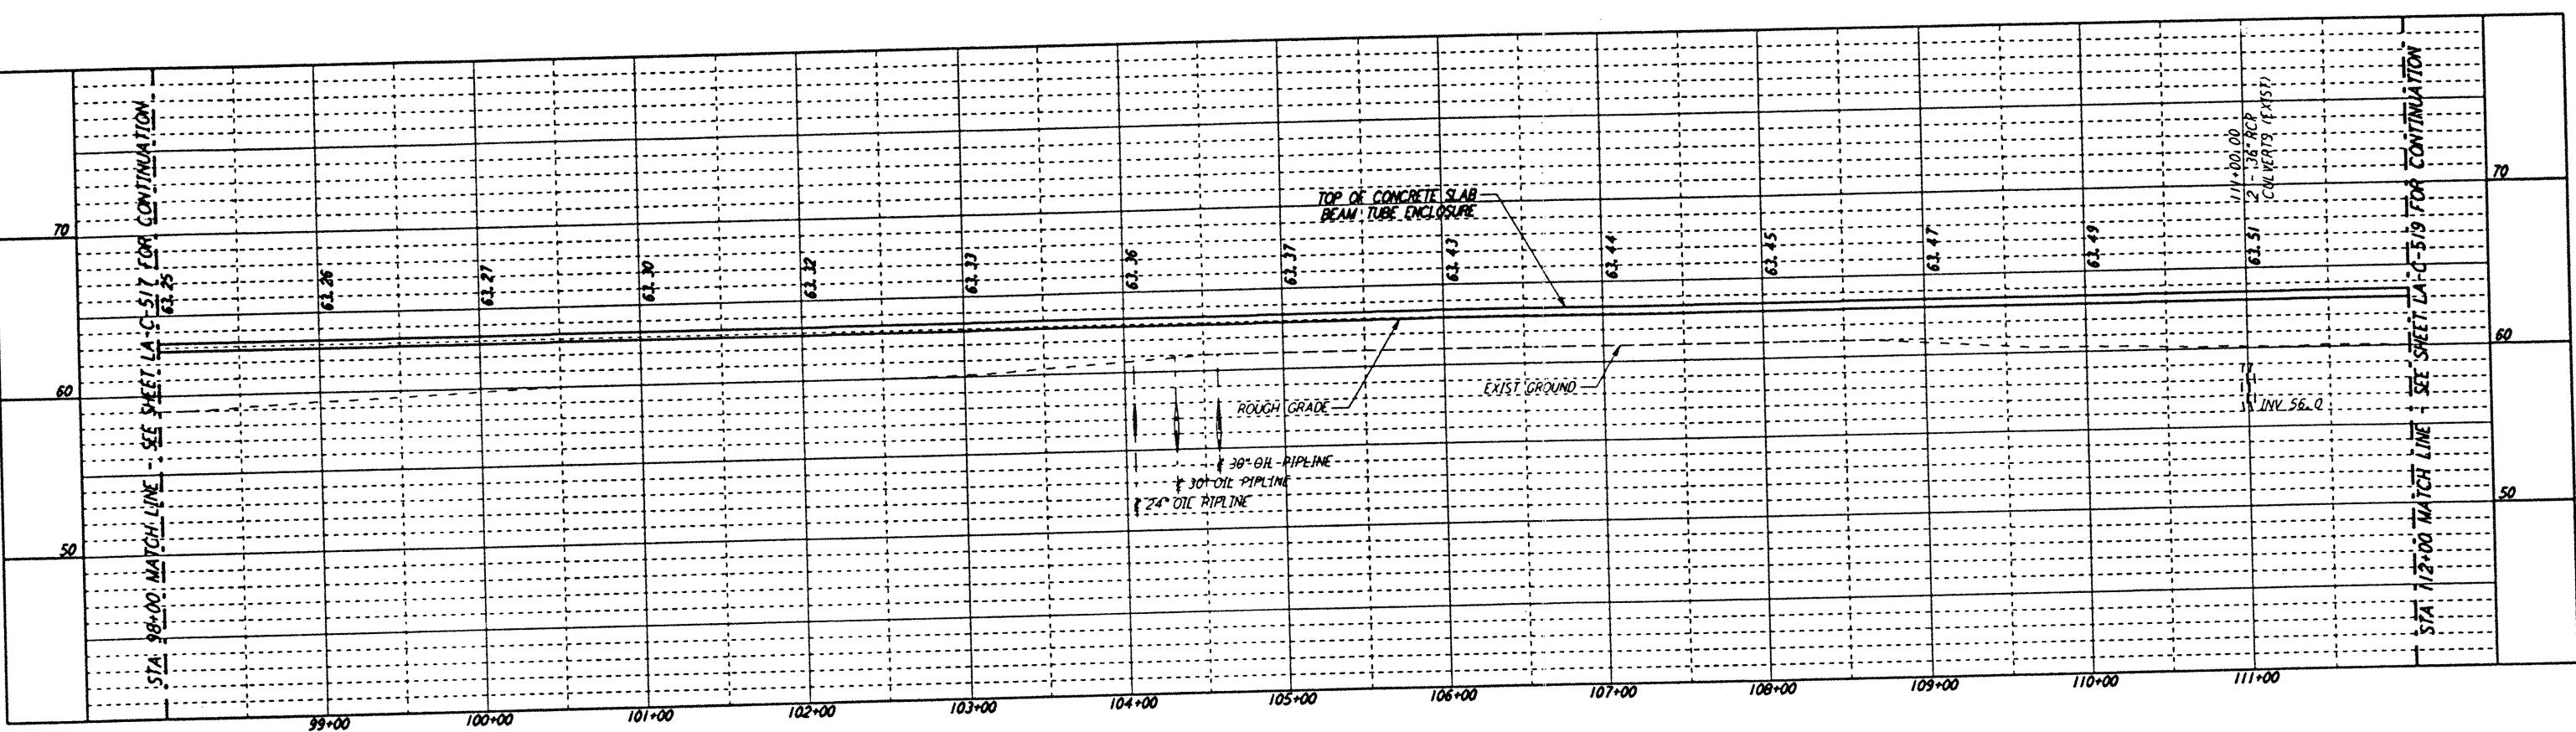

GRAPHIC SCALES
0 50 100 150 200
HORIZONTAL SCALE: 1" = 50'
0 5 10 15 20
VERTICAL SCALE: 1" = 5'

DESCRIPTION	NO.	DATE	BY	CHKO	ENGR	PROJ	REVISIONS
C 9/27/96 WRB NL JB BID ADDENDUM NO. 3							
B 9/10/96 WRB ML JB TDW BID ADDENDUM NO. 2							
A 6/28/96 WRB ML JB TDW FINAL DESIGN REVIEW							

PLAN
SCALE: 1" = 50'

DRAWN	WRB	6/24/96
CHECKED		
ENGINEER		
PROJ		

PARSONS
100 WEST WALNUT STREET
PASADENA, CALIFORNIA

LIGO
CALIFORNIA INSTITUTE OF TECHNOLOGY
MASSACHUSETTS INSTITUTE OF TECHNOLOGY

LASER INTERFEROMETER
GRAVITATIONAL-WAVE OBSERVATORY
BEAM TUBE ENCLOSURE - LIVINGSTON, LA
TITLE: CIVIL SOUTHWEST ARM PLAN AND PROFILE
SHEET NUMBER: LA-C-518
CONTRACT NUMBER: 809.4
STA 98+00 TO STA 112+00
DATE: 09/30/96 TIME: 06:14:47
DESIGN FILE: I:\ligo\site2\ce\loc518.dwg

LIGO-LF1.BDR