





**NOTES:**  
 1. SEE SHEET RG-C-002 FOR GENERAL NOTES, LEGEND AND ABBREVIATIONS.

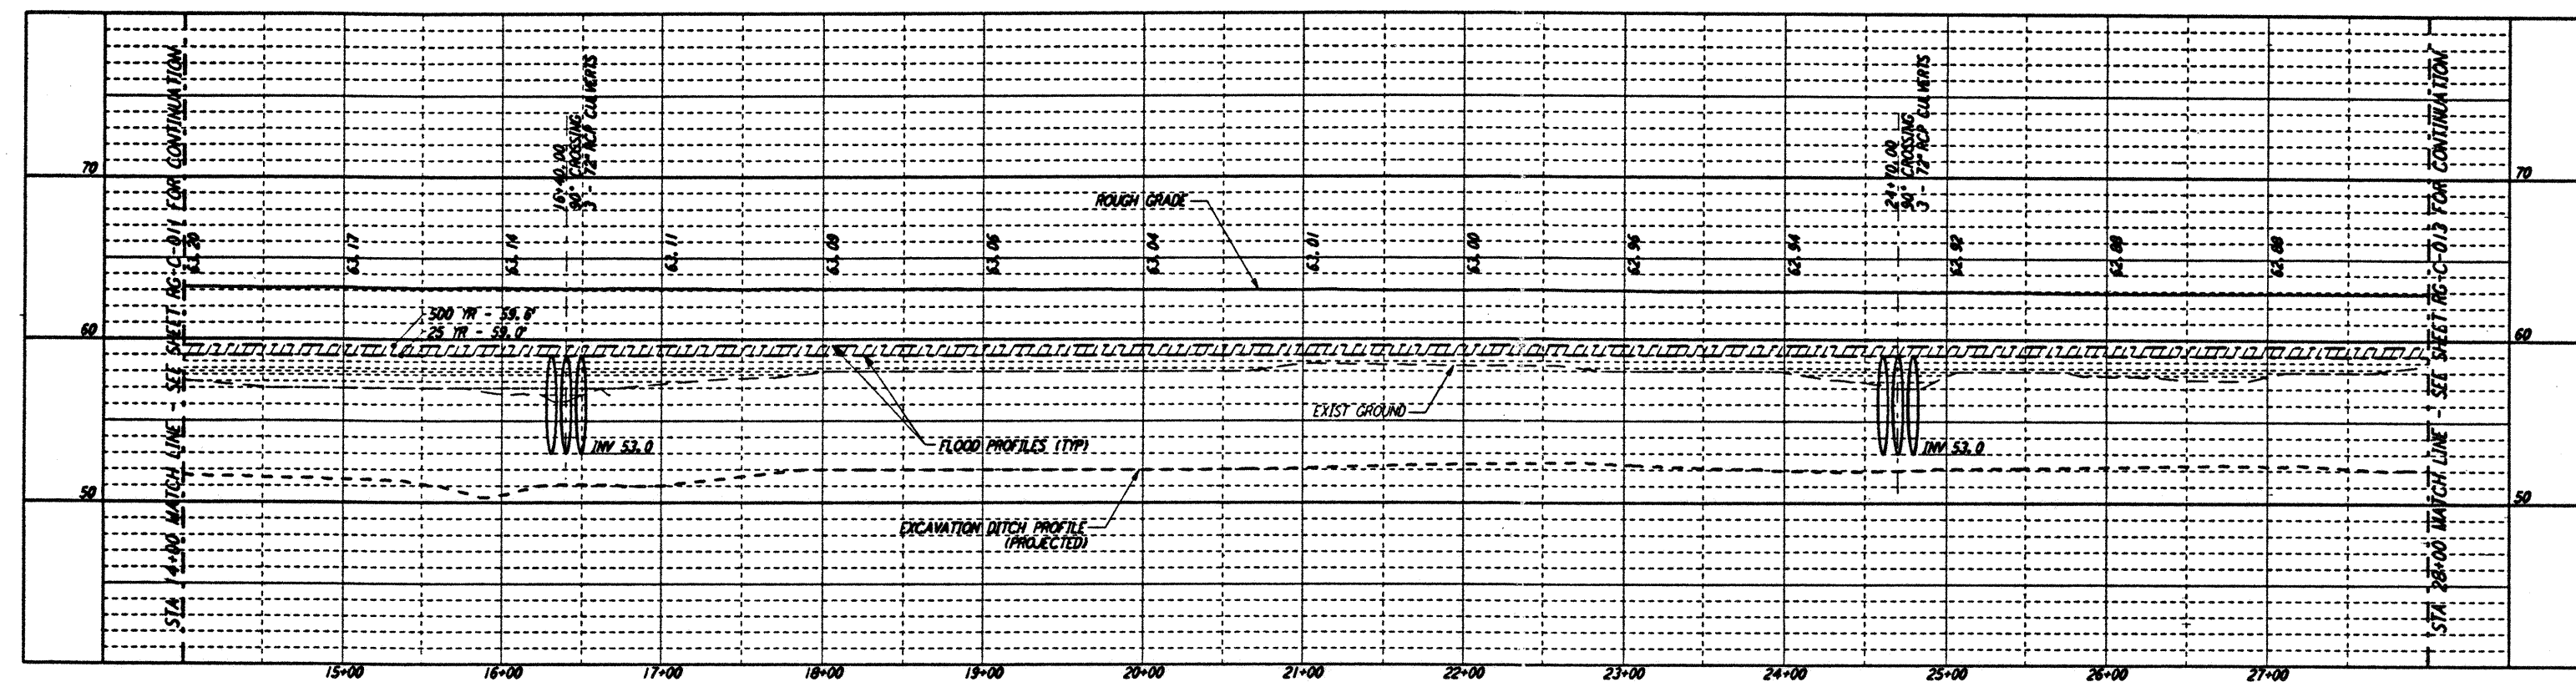

**PROFILE**  
 SCALES: HORIZ: 1" = 50'  
 VERT: 1" = 5'

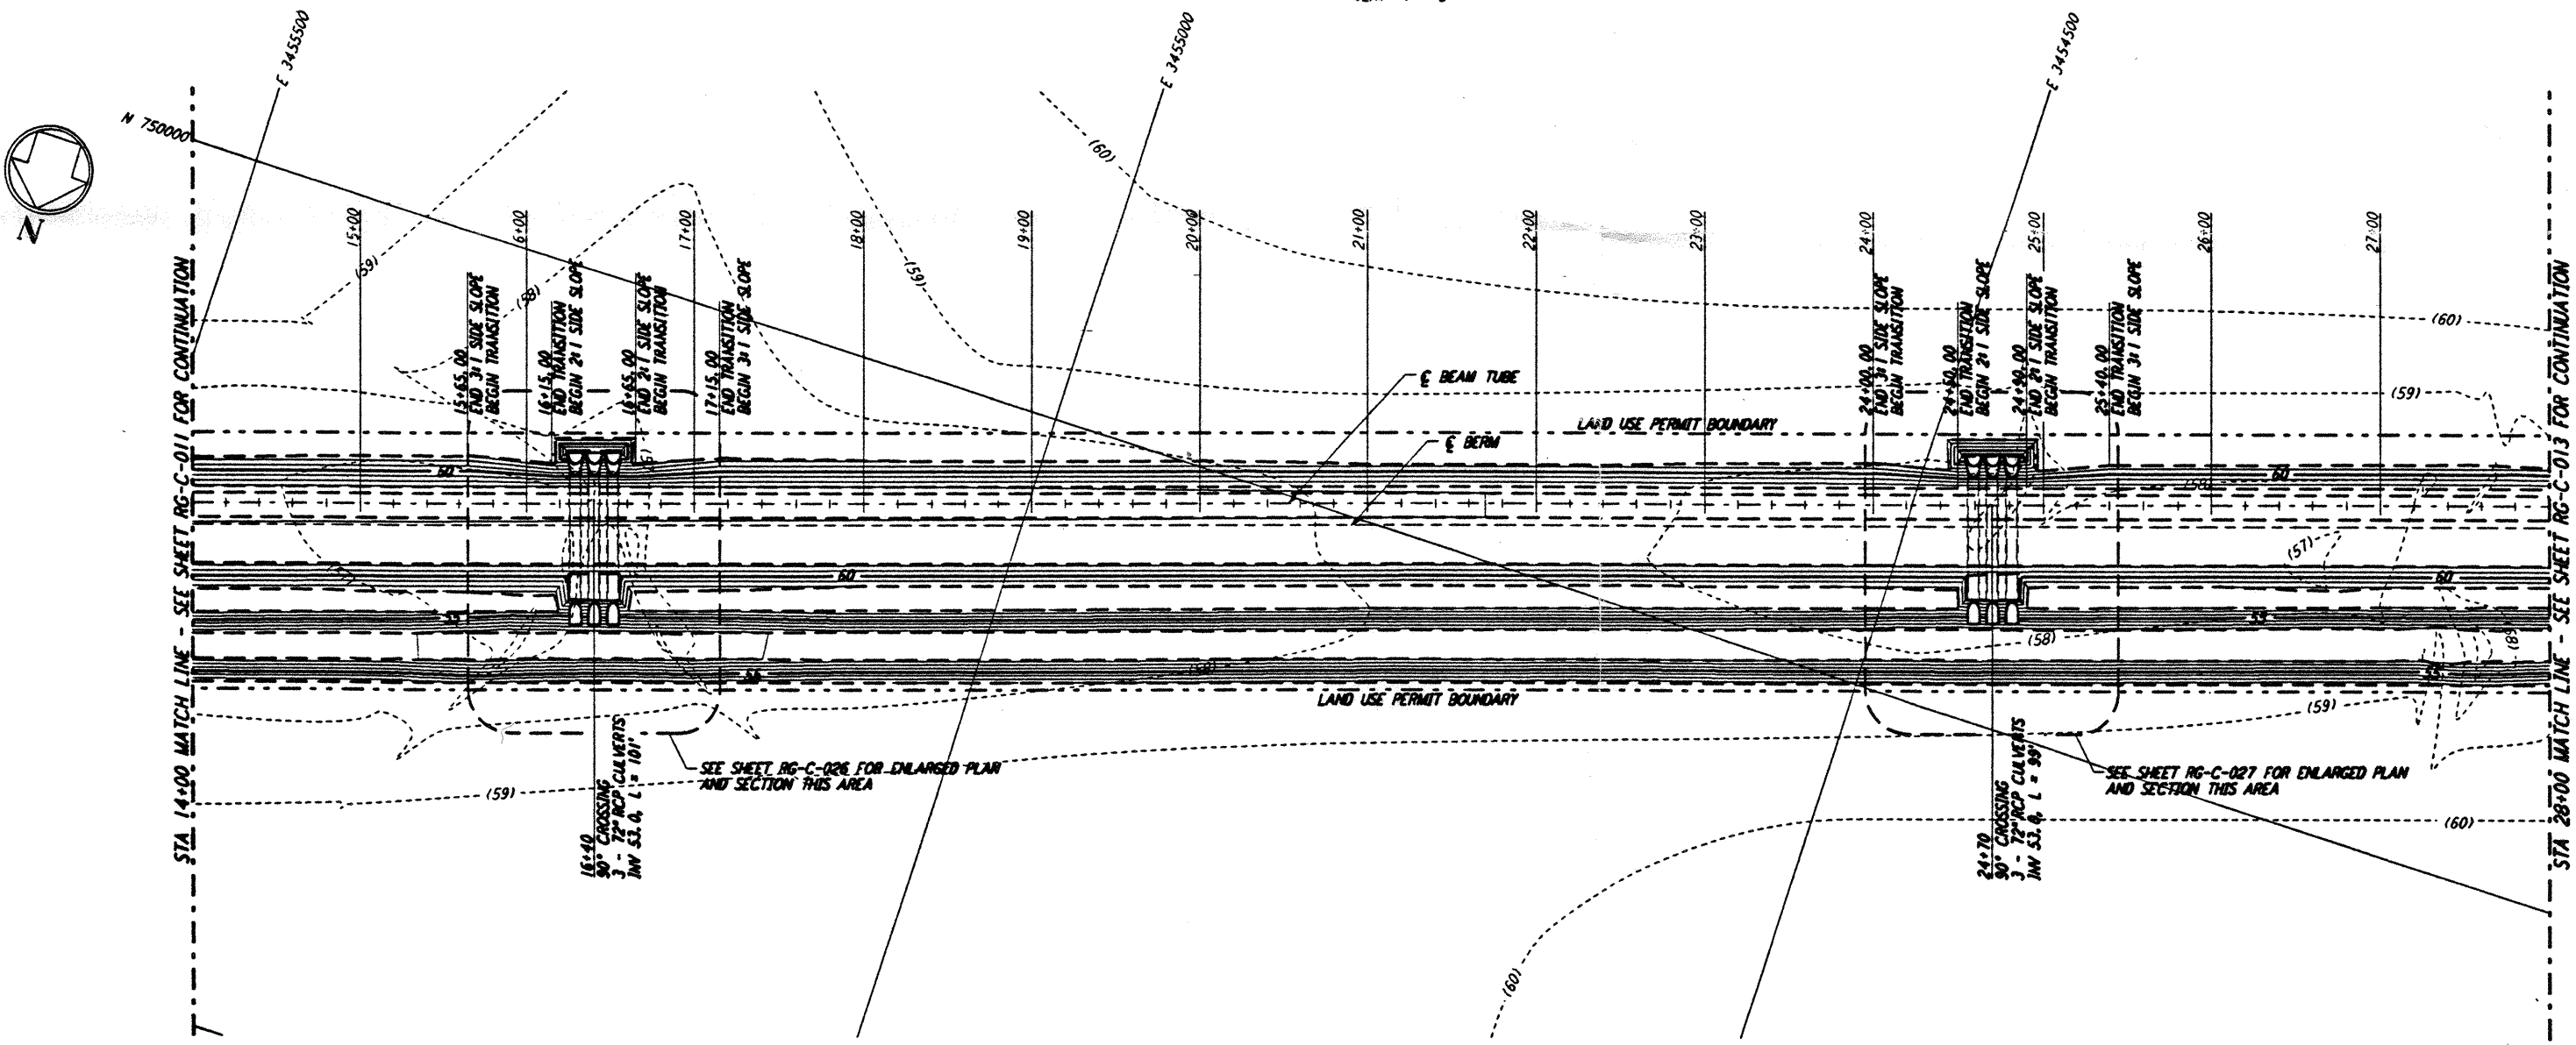

**PLAN**  
 SCALE: 1" = 50'

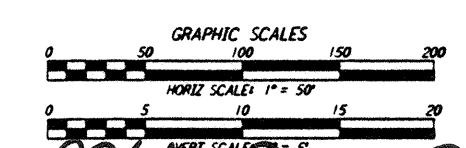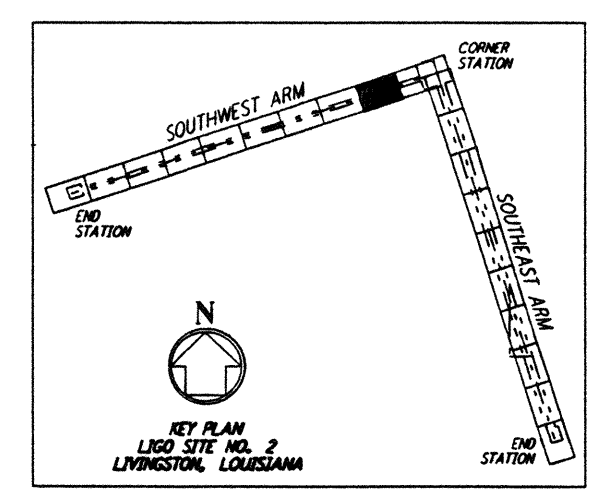

LIGO-0961718-00-0

NO.	DATE	APPRO BY	DESCRIPTION OF REVISION
9			
8			
7			
6			
5			
4			
3			
2			
1	8/28/95	[Signature]	ISSUED FOR BID

NO.	DATE	APPRO BY	ISSUED FOR
9			
8			
7			
6			
5			
4			
3			
2			
1	8/11/95	[Signature]	ISSUED FOR BID

**PARSONS**  
 100 WEST WALNUT STREET  
 PASADENA, CALIFORNIA

**LIGO**  
 CALIFORNIA INSTITUTE OF TECHNOLOGY  
 MASSACHUSETTS INSTITUTE OF TECHNOLOGY

LASER INTERFEROMETER  
 GRAVITATIONAL-WAVE OBSERVATORY  
 ROUGH GRADING - LIVINGSTON, LA

TITLE: **ROUGH GRADING SOUTHWEST ARM PLAN AND PROFILE STA 14+00 TO STA 28+00**

SCALE: CONTRACT NUMBER: **PP150969** PROJECT NUMBER: **8094**

AS NOTED SHEET NUMBER: **RG-C-012**

This document and the design it covers are the property of PARSONS. They are loaned only with the borrower's expressed written agreement that they will not be reproduced, copied, loaned, exhibited, or used in any other way, except by written consent from PARSONS to the borrower.

This document and the design it covers are the property of PARSONS. They are loaned only with the borrower's expressed written agreement that they will not be reproduced, copied, loaned, exhibited, or used in any other way, except by written consent from PARSONS to the borrower.

5

4

3

2

5

4

3

2

E  
 D  
 C  
 B  
 A